





## Allan Block – Drainage Details


### Alternate Drain Wall Section

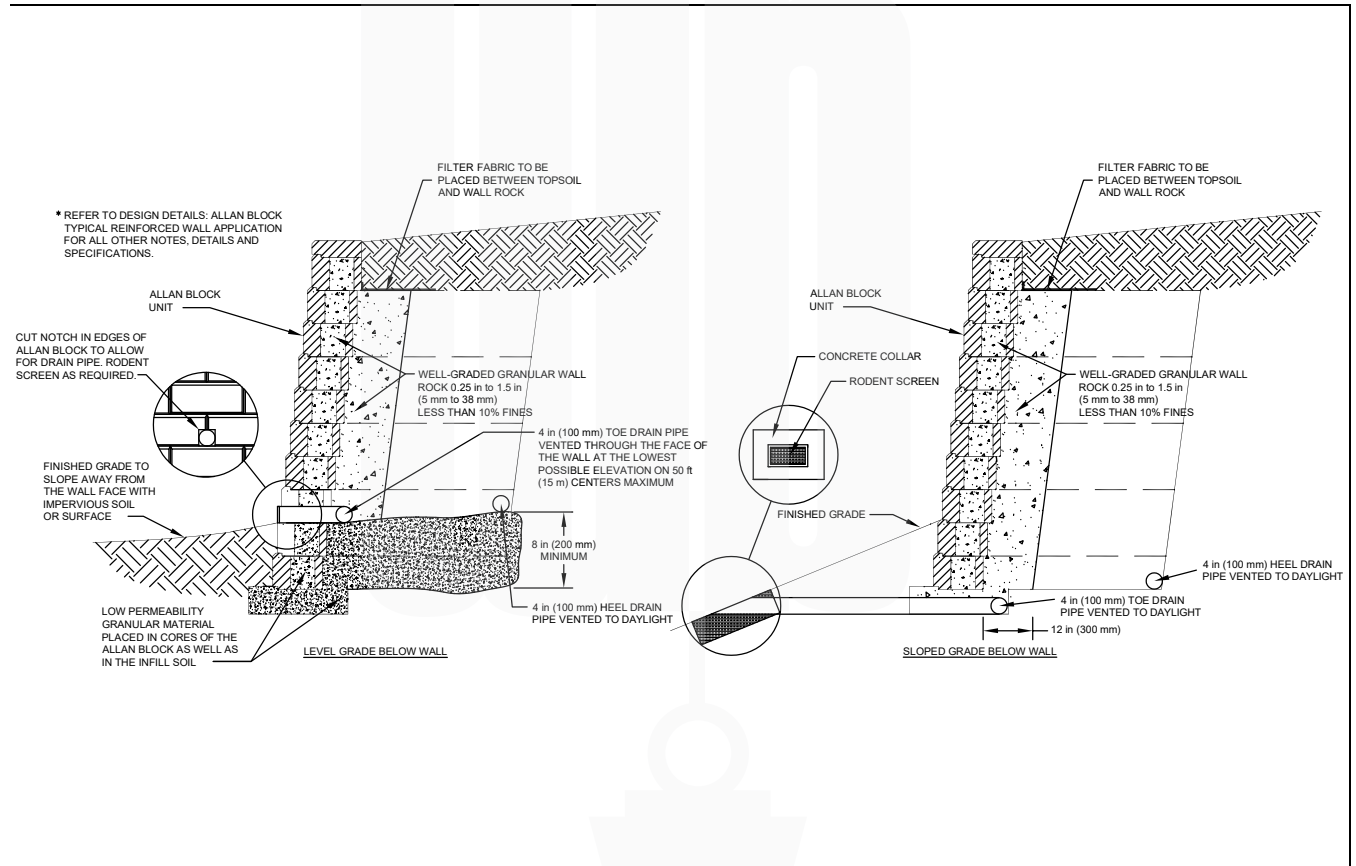

Designed By:	Title: <b>ALTERNATE DRAIN WALL SECTIONS</b>	Date:
Checked By:	 <p>The purpose of this drawing is for preliminary design only. This drawing should not be used for final design or construction without the certification of a professional engineer registered in the state in which the wall will be built. The accuracy and use of details contained in this document are the sole responsibility of the user. The user must verify each detail for accuracy as they pertain to their particular project.</p> <p>© 2005 Allan Block</p>	Project No:
Scale: NOT TO SCALE		Drawing No:




### Pavement and Earth Lined Swales

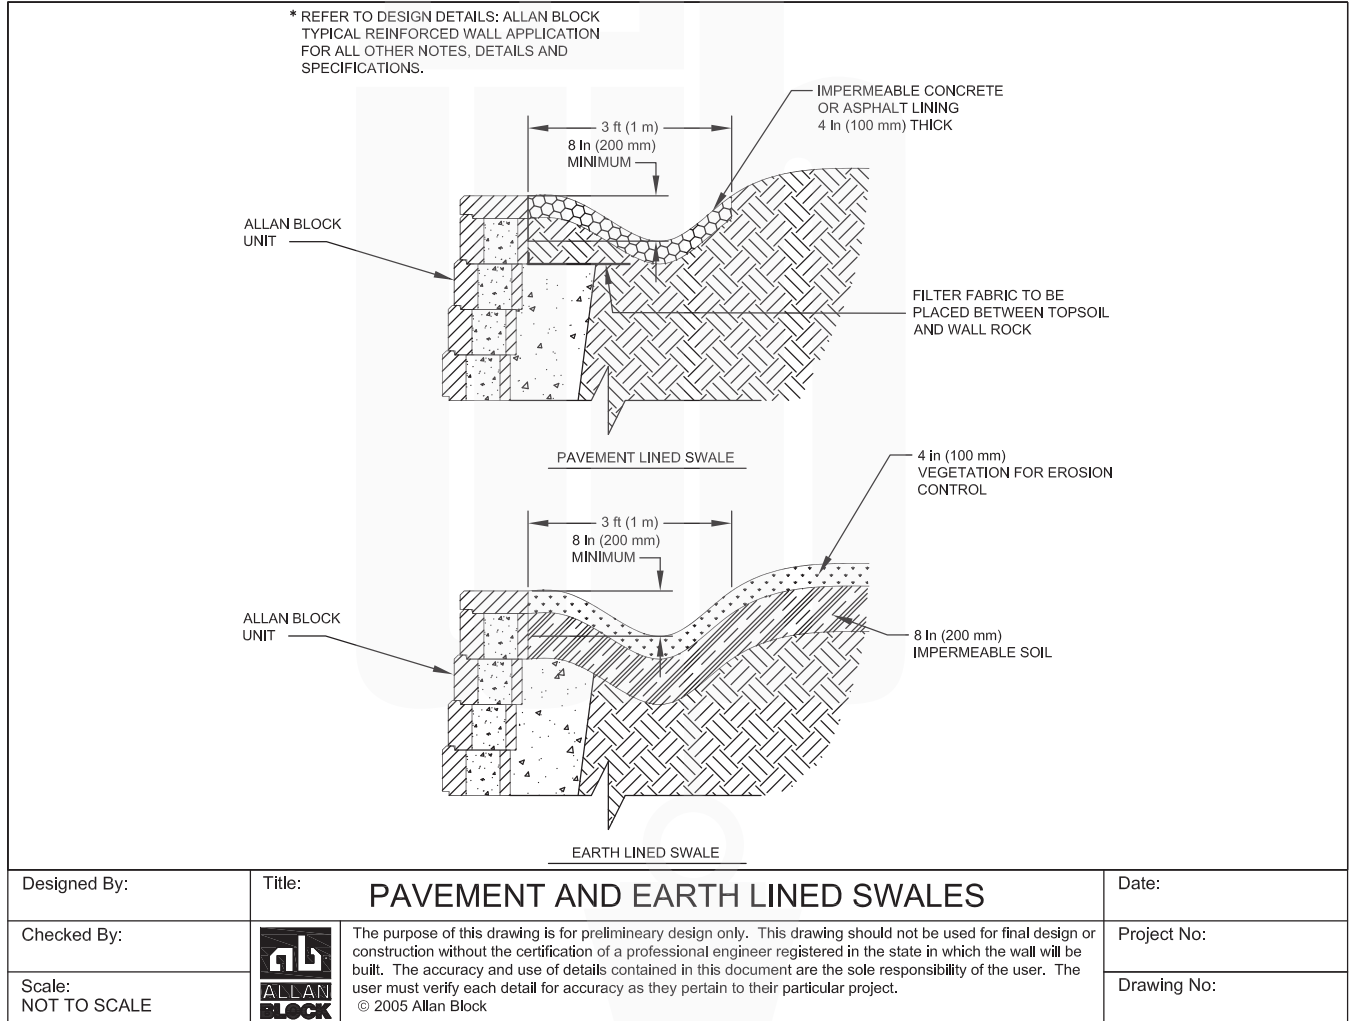




### Chimney Application

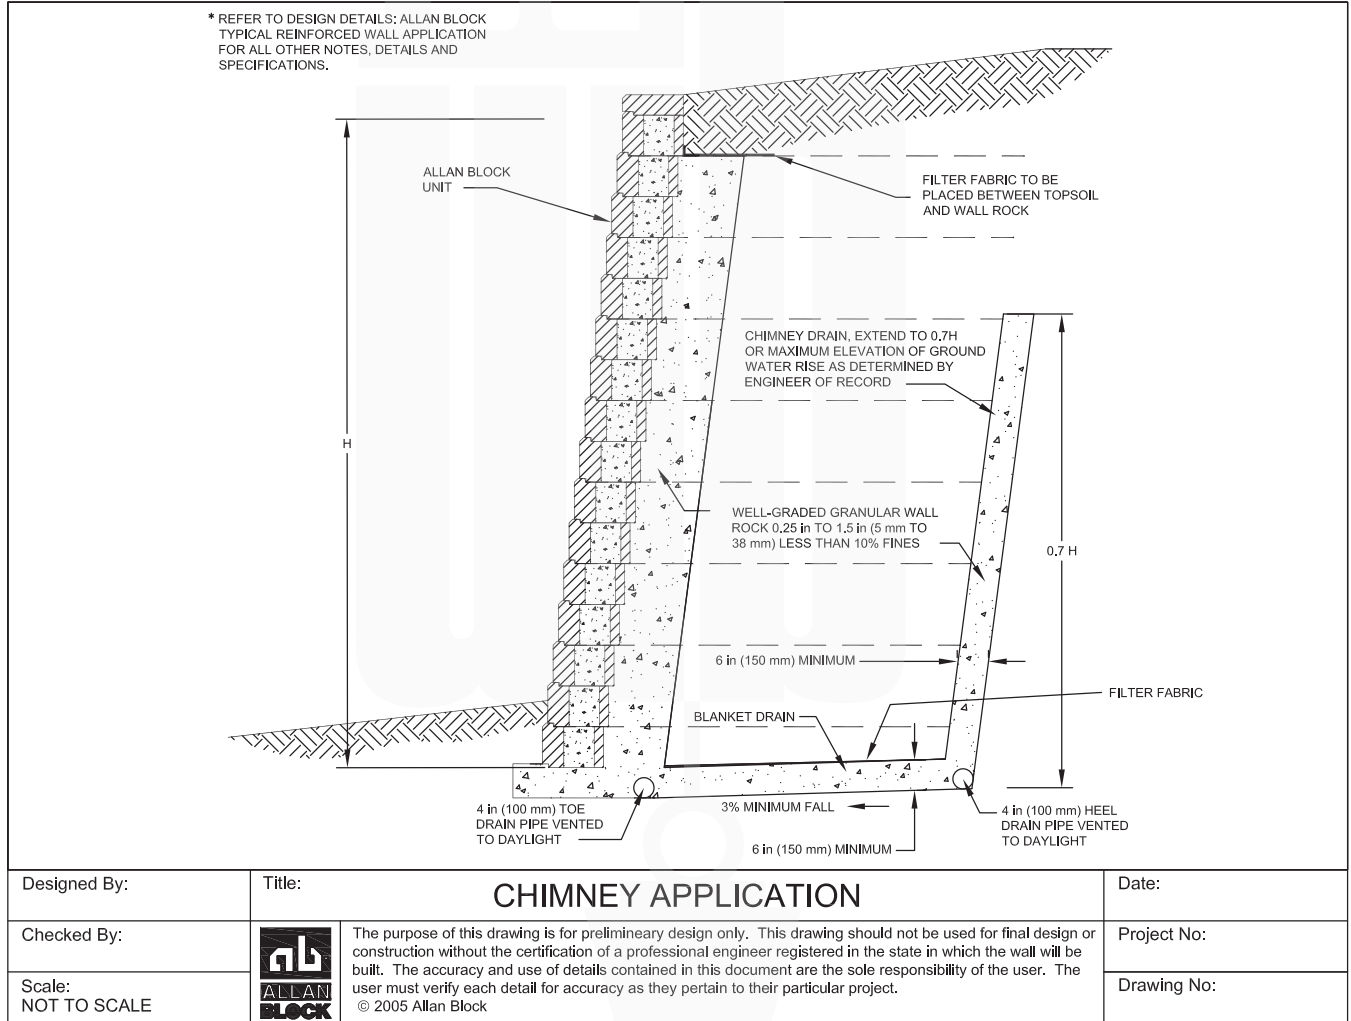




### Double-Wide Gravity Wall


\* REFER TO DESIGN DETAILS: ALLAN BLOCK TYPICAL REINFORCED WALL APPLICATION FOR ALL OTHER NOTES, DETAILS AND SPECIFICATIONS.

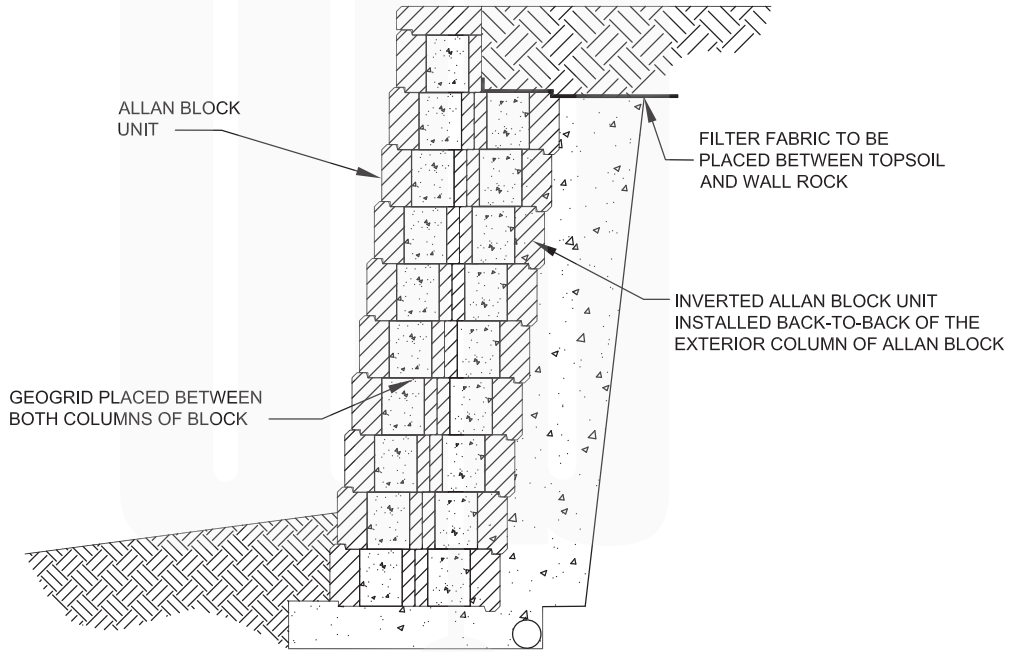

Designed By:	Title: <b>DOUBLE-WIDE GRAVITY WALL</b>	Date:
Checked By:	 <p>The purpose of this drawing is for preliminary design only. This drawing should not be used for final design or construction without the certification of a professional engineer registered in the state in which the wall will be built. The accuracy and use of details contained in this document are the sole responsibility of the user. The user must verify each detail for accuracy as they pertain to their particular project. © 2005 Allan Block</p>	Project No:
Scale: NOT TO SCALE		Drawing No:





### Masonry Wall Application

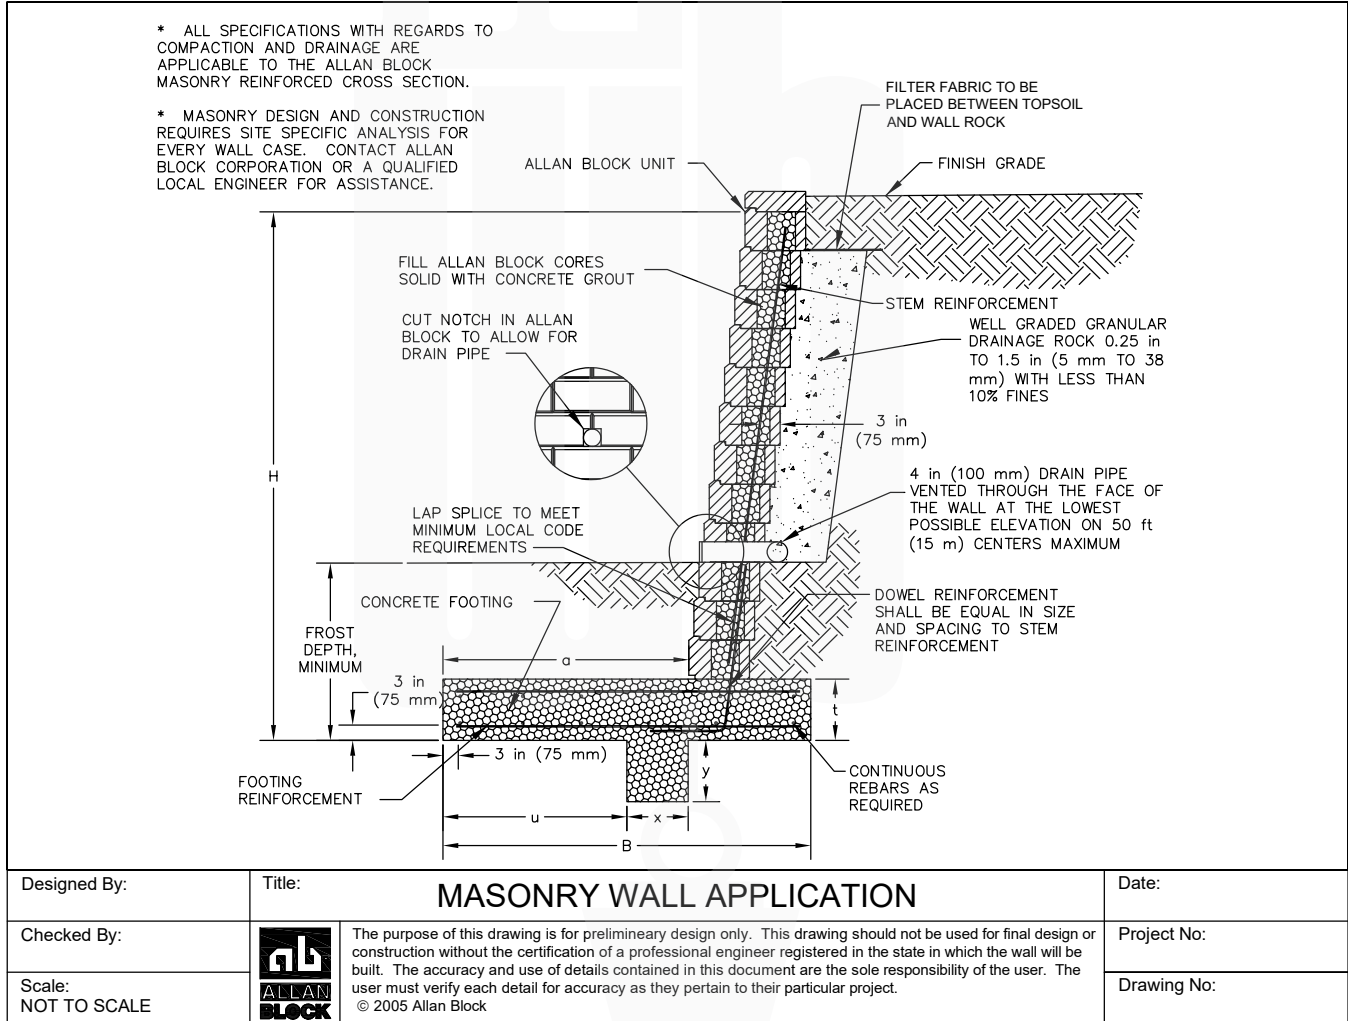



### Veneer Wall Section

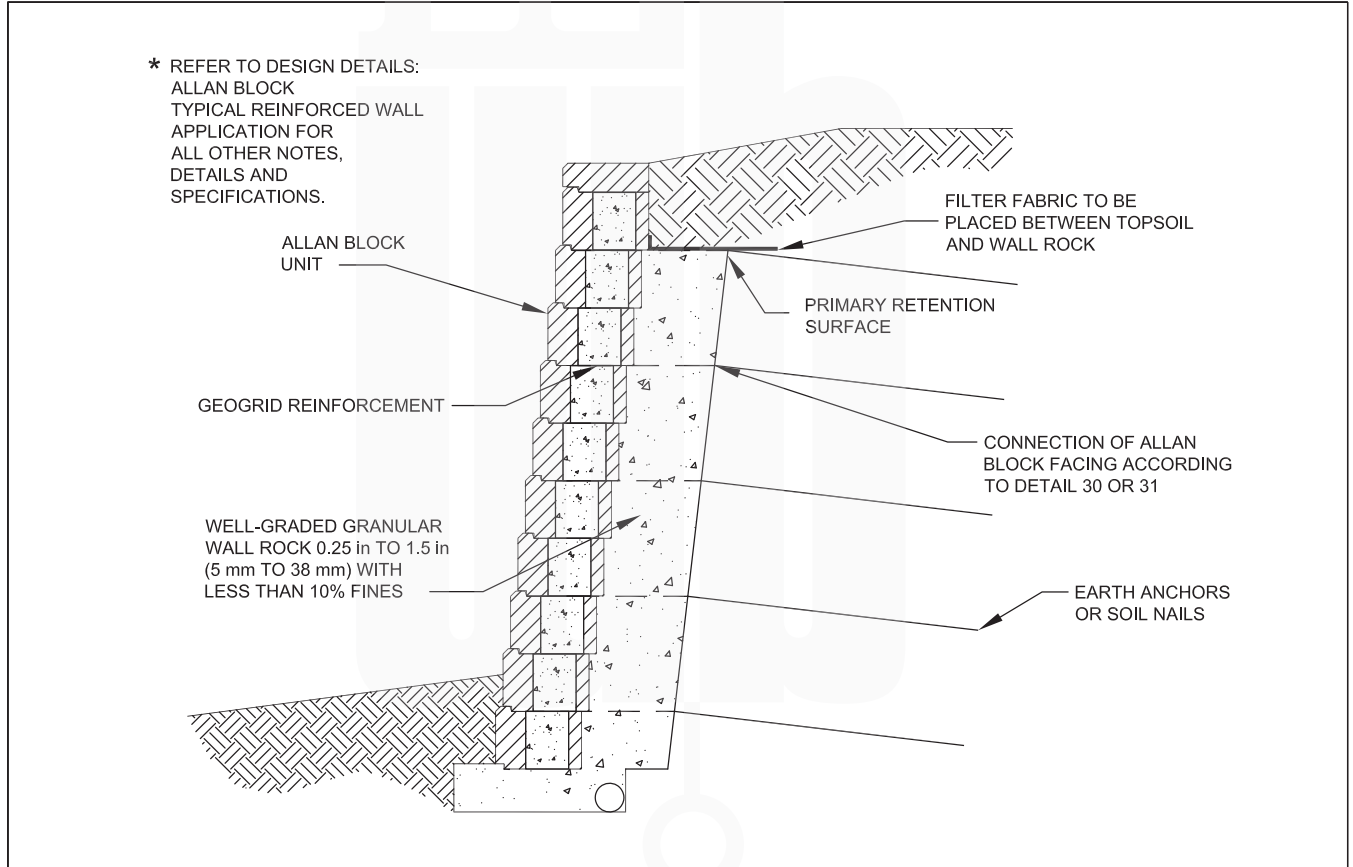



Designed By:	Title: <b>VENEER WALL SECTION</b>		Date:
Checked By:	 <p>The purpose of this drawing is for preliminary design only. This drawing should not be used for final design or construction without the certification of a professional engineer registered in the state in which the wall will be built. The accuracy and use of details contained in this document are the sole responsibility of the user. The user must verify each detail for accuracy as they pertain to their particular project. © 2005 Allan Block</p>	Project No:	
Scale: NOT TO SCALE		Drawing No:	



### Nail Connection Detail


\* REFER TO DESIGN DETAILS: ALLAN BLOCK TYPICAL REINFORCED WALL APPLICATION FOR ALL OTHER NOTES, DETAILS AND SPECIFICATIONS.

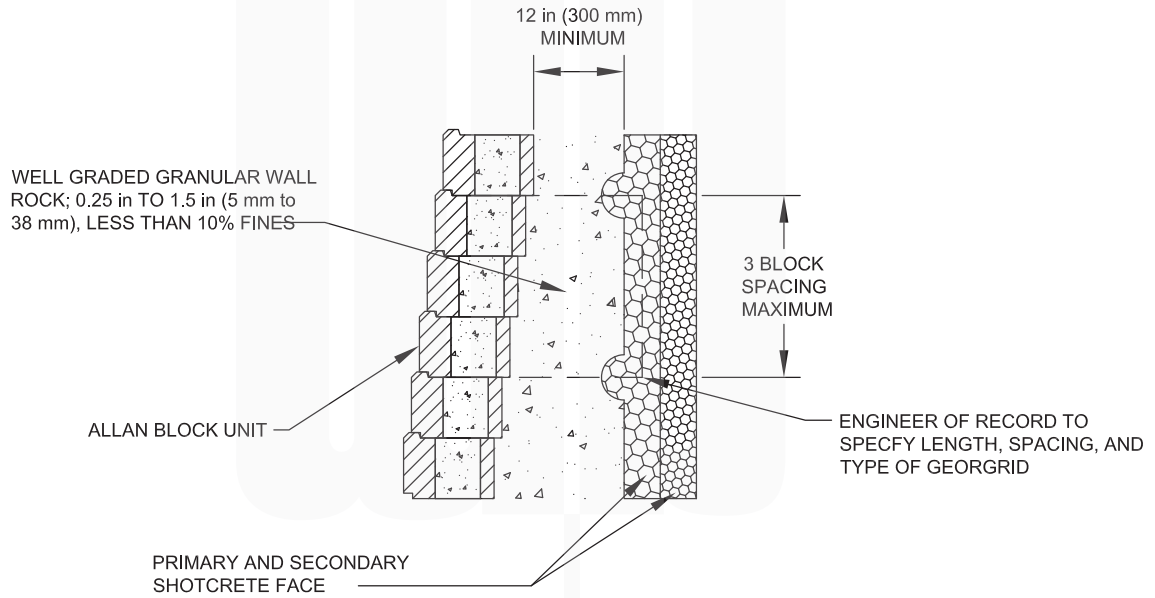


Designed By:	Title: <b>NAIL CONNECTION DETAIL</b>	Date:
Checked By:	 <p>The purpose of this drawing is for preliminary design only. This drawing should not be used for final design or construction without the certification of a professional engineer registered in the state in which the wall will be built. The accuracy and use of details contained in this document are the sole responsibility of the user. The user must verify each detail for accuracy as they pertain to their particular project. © 2005 Allan Block</p>	Project No:
Scale: NOT TO SCALE		Drawing No:



### Anchor Connection Detail

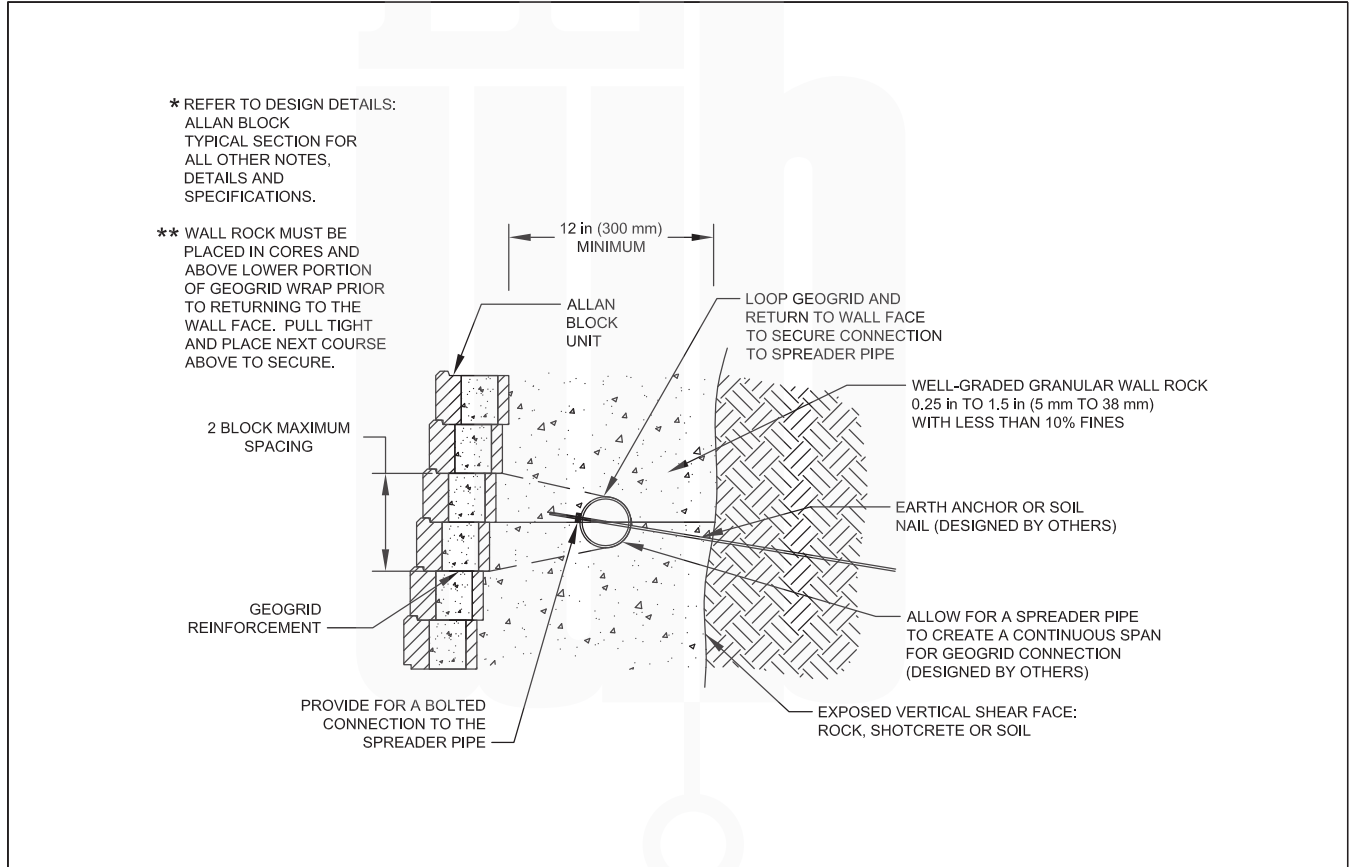





Designed By:	Title: <b>ANCHOR CONNECTION DETAIL</b>	Date:
Checked By:	 <p>The purpose of this drawing is for preliminary design only. This drawing should not be used for final design or construction without the certification of a professional engineer registered in the state in which the wall will be built. The accuracy and use of details contained in this document are the sole responsibility of the user. The user must verify each detail for accuracy as they pertain to their particular project. © 2005 Allan Block</p>	Project No:
Scale: NOT TO SCALE		Drawing No:






### Allan Block Step Finishing Details

\* REFER TO DESIGN DETAILS:  
ALLAN BLOCK TYPICAL  
REINFORCED WALL APPLICATION  
FOR ALL OTHER NOTES, DETAILS  
AND SPECIFICATIONS.

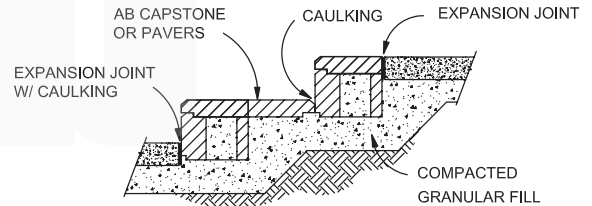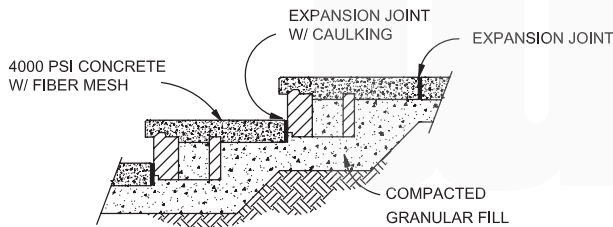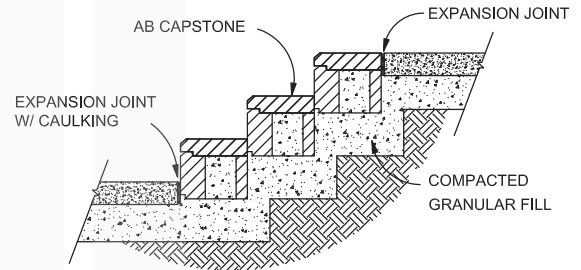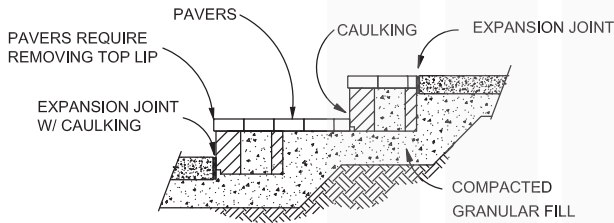

Designed By:	Title: <b>AB STEP FINISHING DETAILS</b>	Date:
Checked By:	 <p>The purpose of this drawing is for preliminary design only. This drawing should not be used for final design or construction without the certification of a professional engineer registered in the state in which the wall will be built. The accuracy and use of details contained in this document are the sole responsibility of the user. The user must verify each detail for accuracy as they pertain to their particular project. © 2005 Allan Block</p>	Project No:
Scale: NOT TO SCALE		Drawing No: