





Allan Block – Parapets Details


Allan Block Fieldstone Parapet

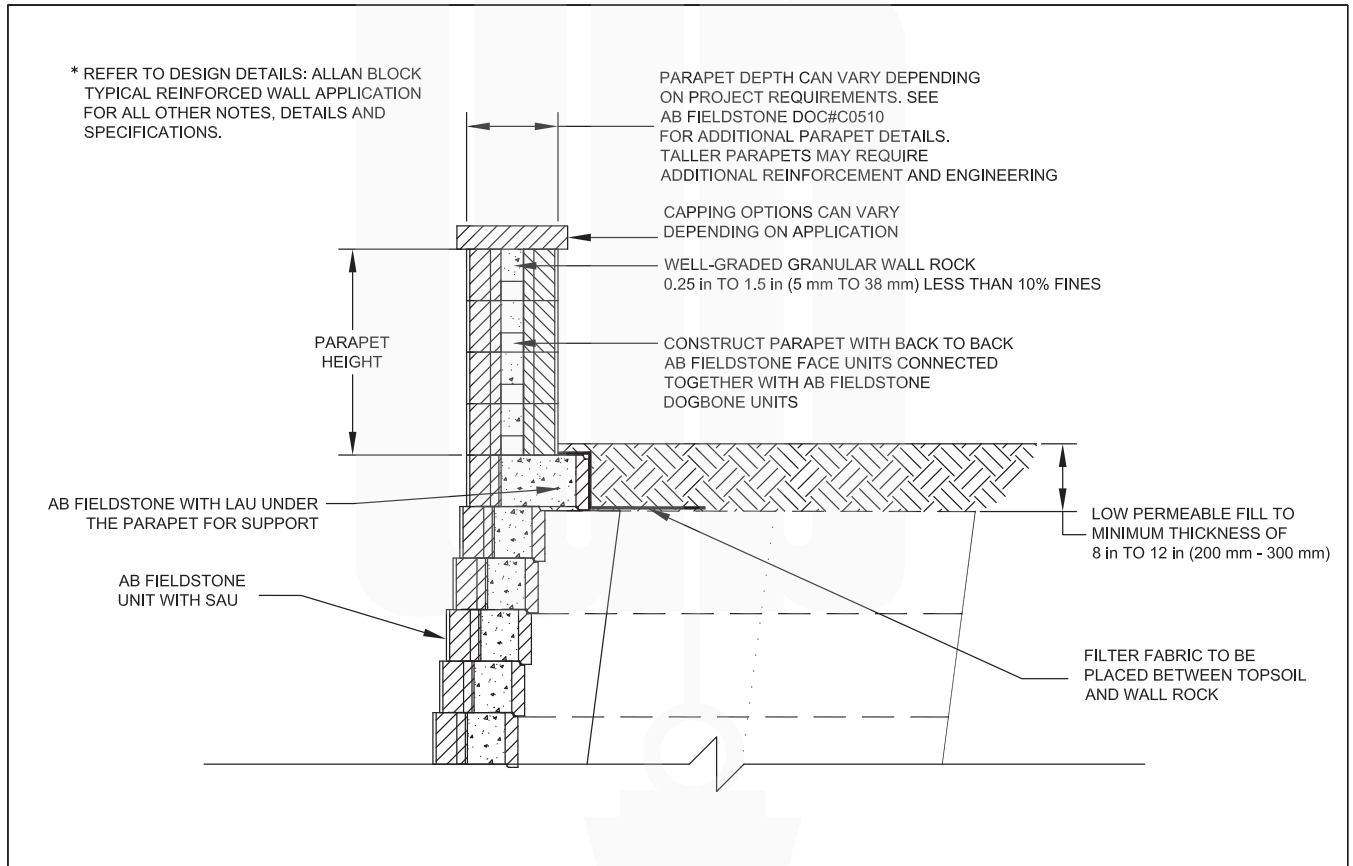


Designed By:	Title: AB FIELDSTONE PARAPET	Date:
Checked By:	 <p>The purpose of this drawing is for preliminary design only. This drawing should not be used for final design or construction without the certification of a professional engineer registered in the state in which the wall will be built. The accuracy and use of details contained in this document are the sole responsibility of the user. The user must verify each detail for accuracy as they pertain to their particular project. © 2015 Allan Block</p>	Project No:
Scale: NOT TO SCALE		Drawing No:




Straight Parapets – No Cutting Needed

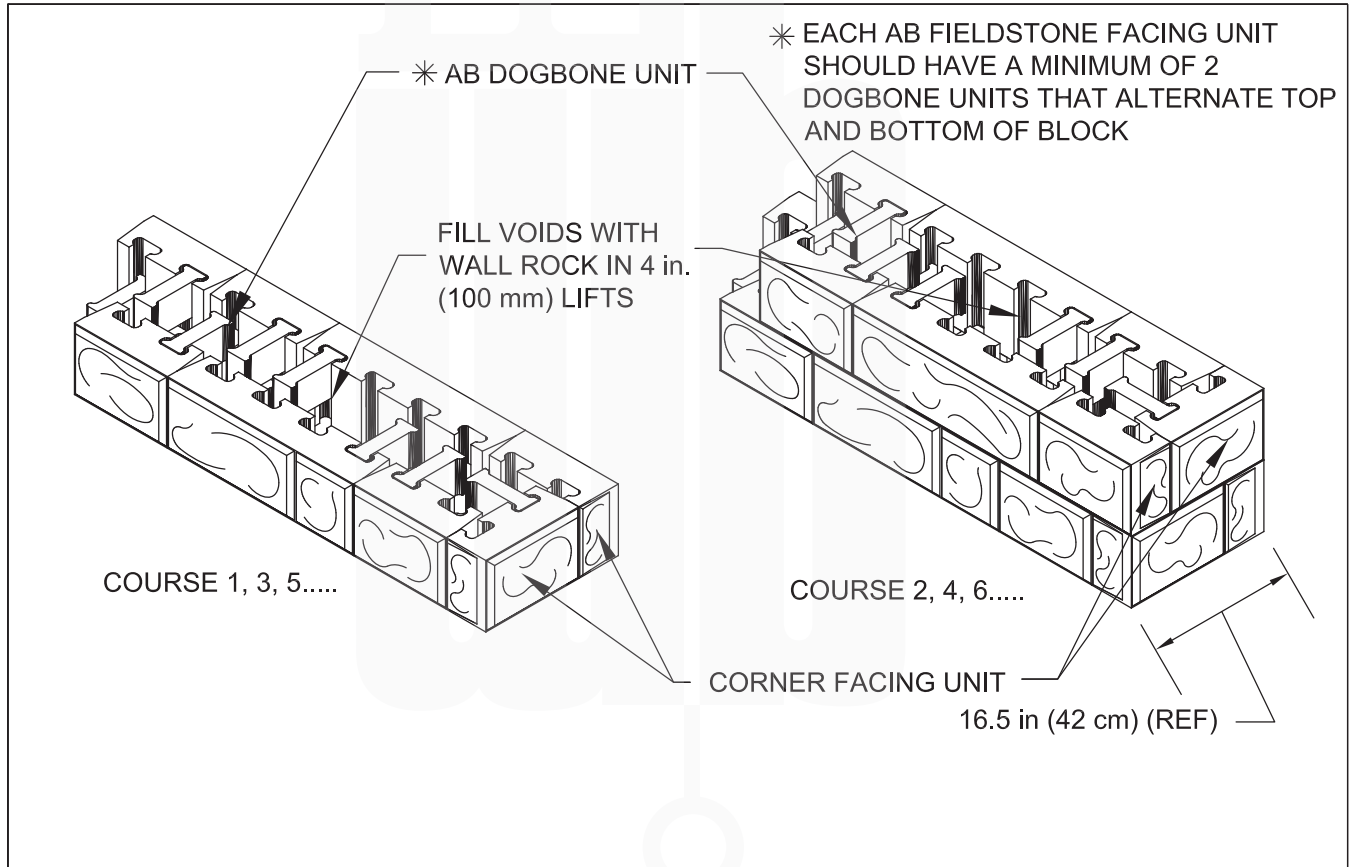


Designed By:	Title: STRAIGHT PARAPETS - NO CUTTING NEEDED	Date:
Checked By:	 <p>The purpose of this drawing is for preliminary design only. This drawing should not be used for final design or construction without the certification of a professional engineer registered in the state in which the wall will be built. The accuracy and use of details contained in this document are the sole responsibility of the user. The user must verify each detail for accuracy as they pertain to their particular project. © 2015 Allan Block</p>	Project No:
Scale: NOT TO SCALE		Drawing No:




Curved Parapets

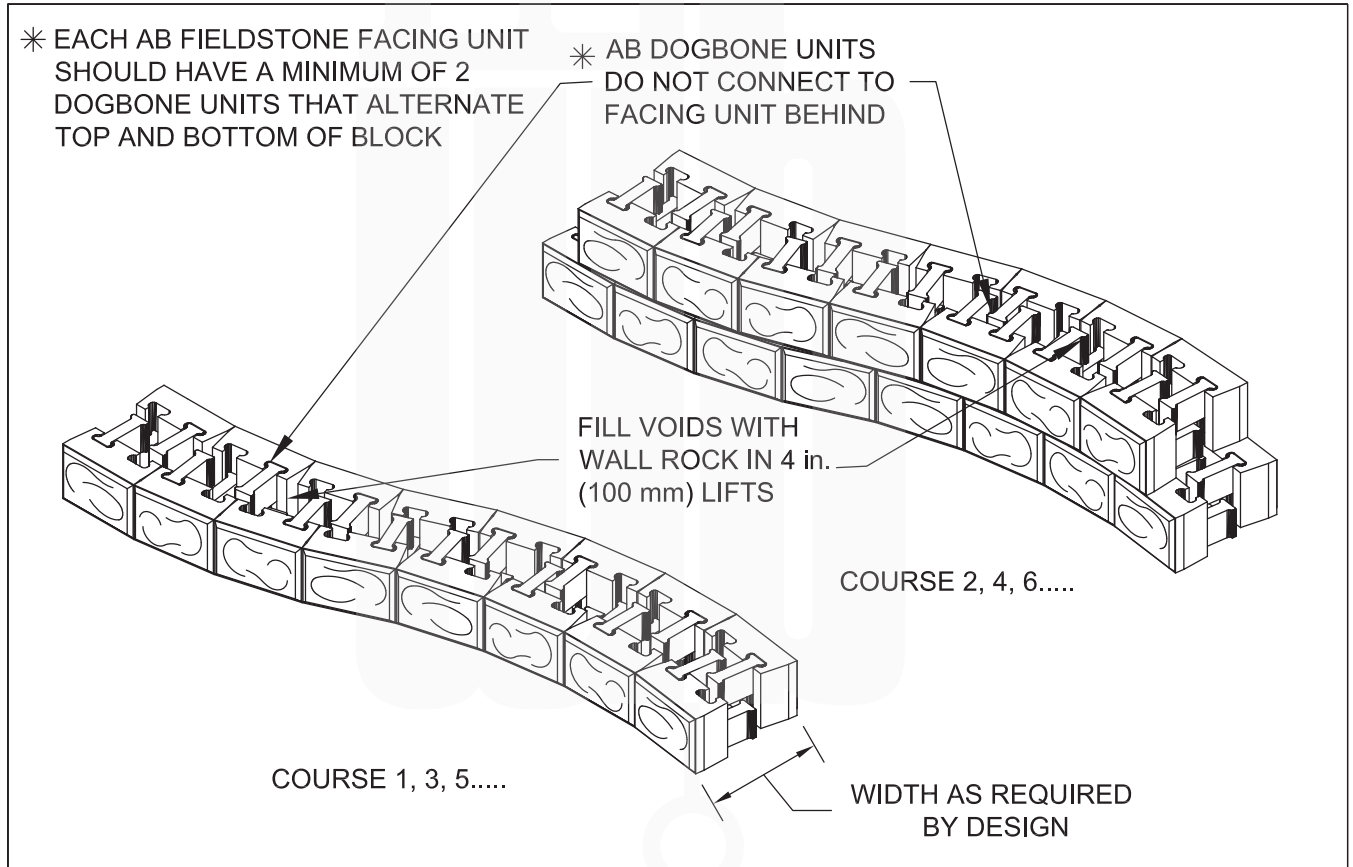

Designed By:	Title: CURVED PARAPETS		Date:
Checked By:	 <p>The purpose of this drawing is for preliminary design only. This drawing should not be used for final design or construction without the certification of a professional engineer registered in the state in which the wall will be built. The accuracy and use of details contained in this document are the sole responsibility of the user. The user must verify each detail for accuracy as they pertain to their particular project. © 2015 Allan Block</p>	Project No:	
Scale: NOT TO SCALE		Drawing No:	




Standard Parapets with Corners

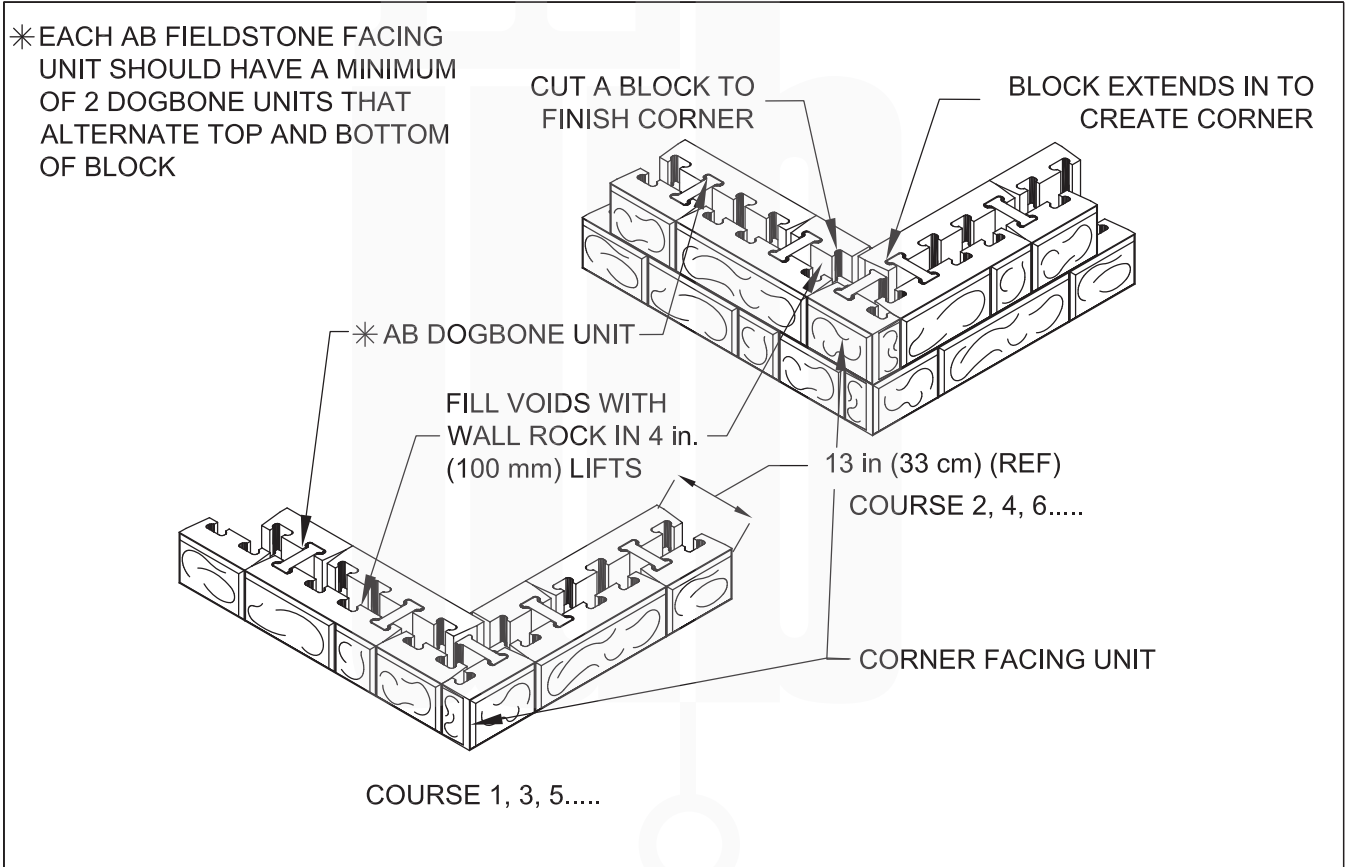

Designed By:	Title: STANDARD PARAPETS WITH CORNERS	Date:
Checked By:	 <p>The purpose of this drawing is for preliminary design only. This drawing should not be used for final design or construction without the certification of a professional engineer registered in the state in which the wall will be built. The accuracy and use of details contained in this document are the sole responsibility of the user. The user must verify each detail for accuracy as they pertain to their particular project. © 2015 Allan Block</p>	Project No:
Scale: NOT TO SCALE		Drawing No:





Parapets with Posts

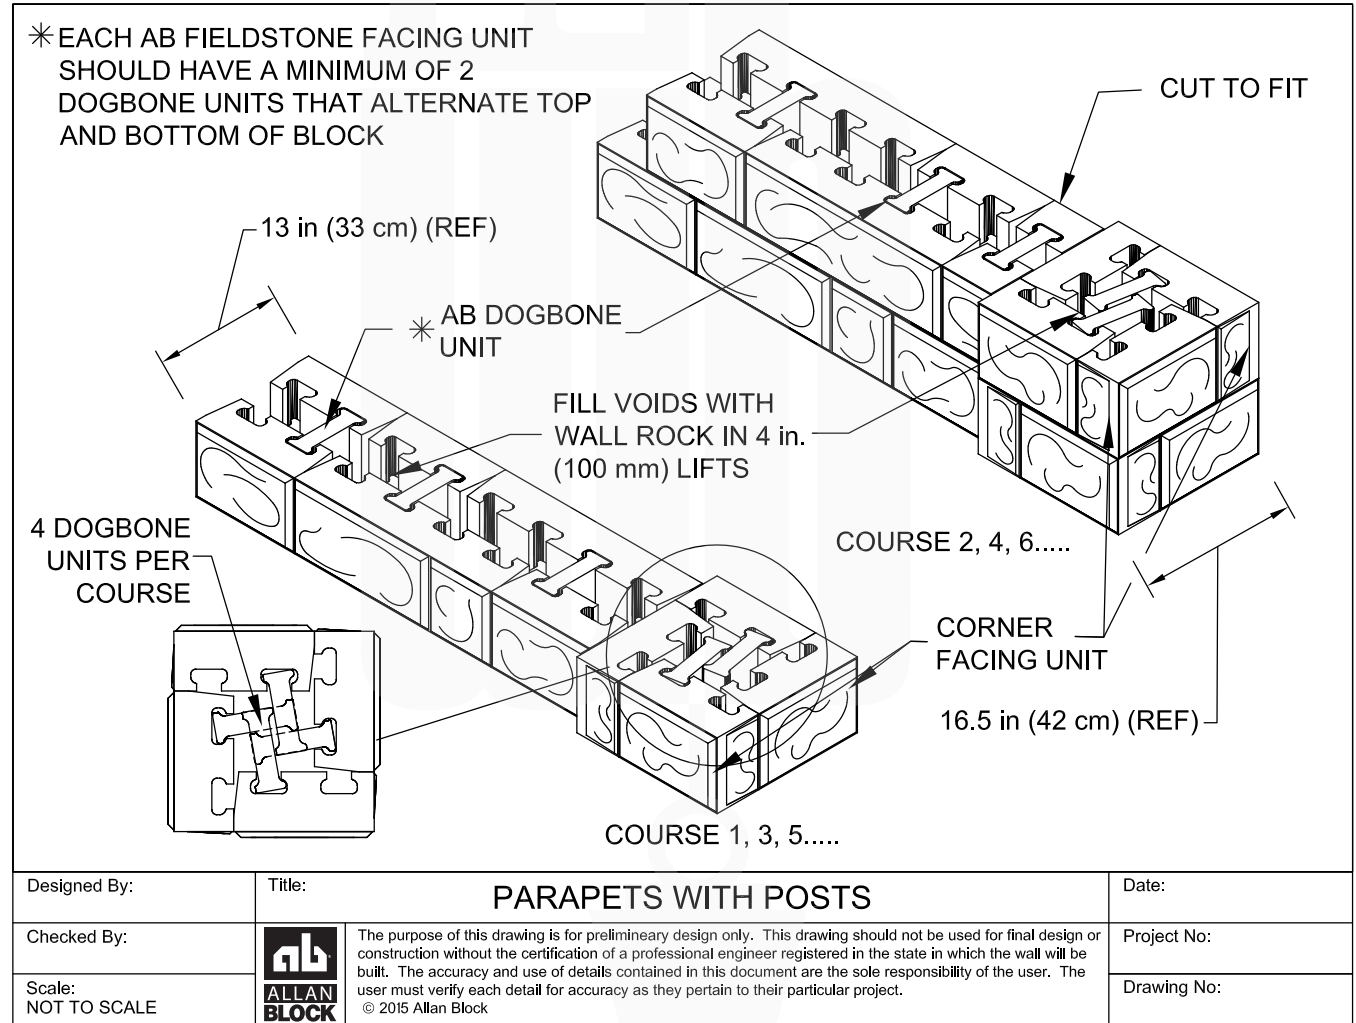




Masonry Parapet Wall Section

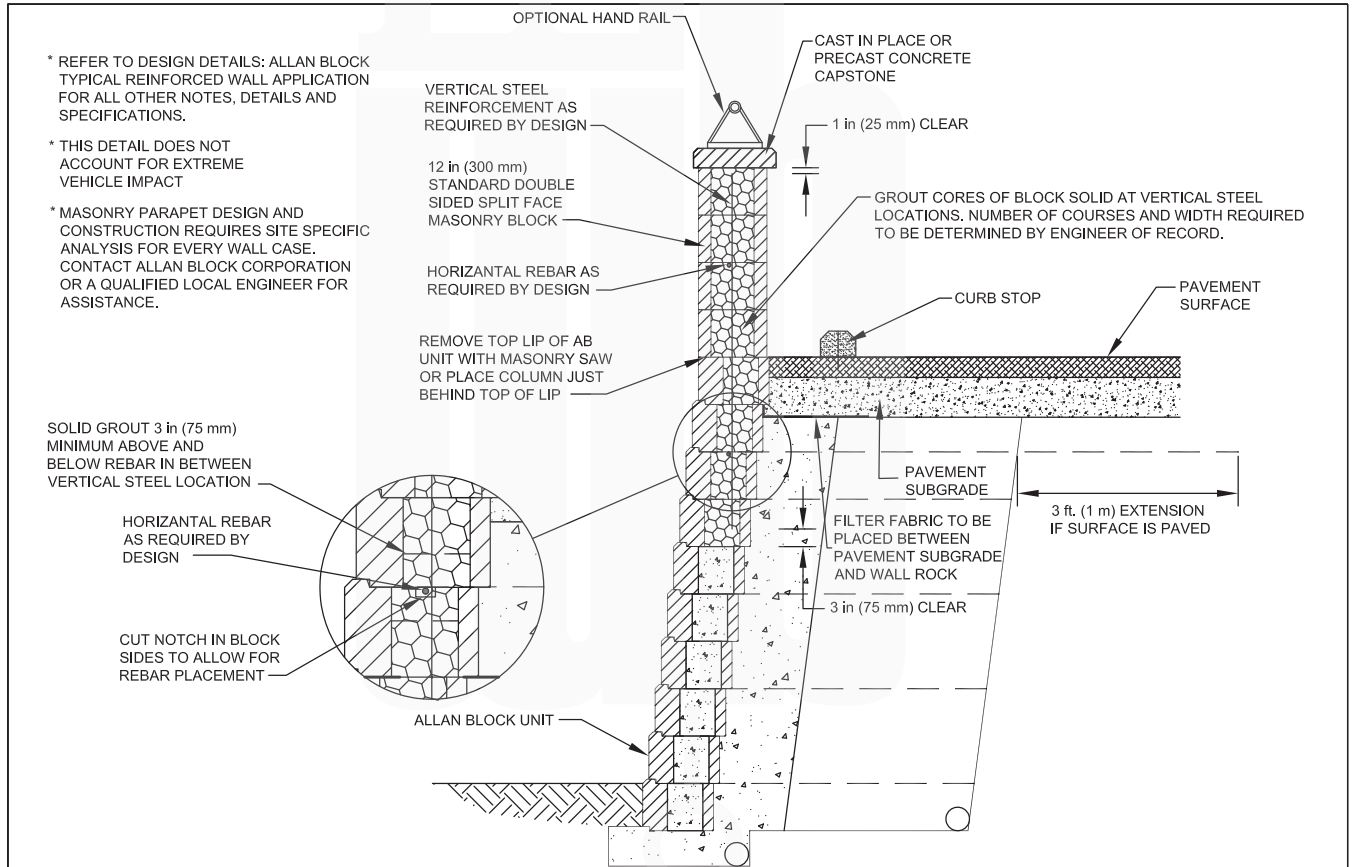

Designed By:	Title: MASONRY PARAPET WALL SECTION	Date:
Checked By:	 <p>The purpose of this drawing is for preliminary design only. This drawing should not be used for final design or construction without the certification of a professional engineer registered in the state in which the wall will be built. The accuracy and use of details contained in this document are the sole responsibility of the user. The user must verify each detail for accuracy as they pertain to their particular project.</p> <p>© 2005 Allan Block</p>	Project No:
Scale: NOT TO SCALE		Drawing No:




Double Wall Parapet Section

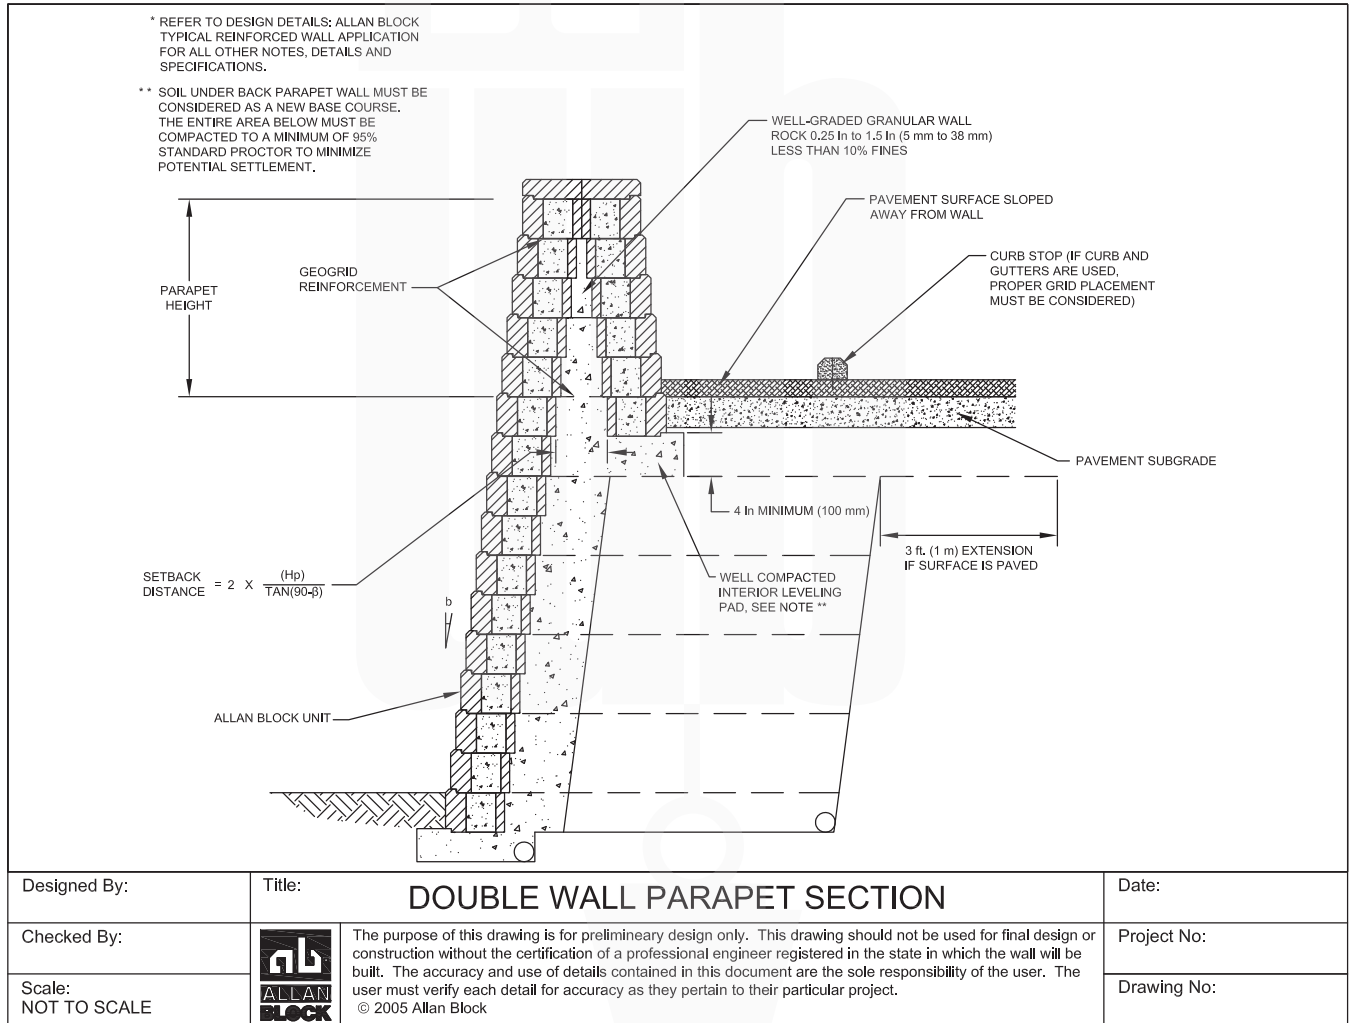




Non Impact Railing Wall Section

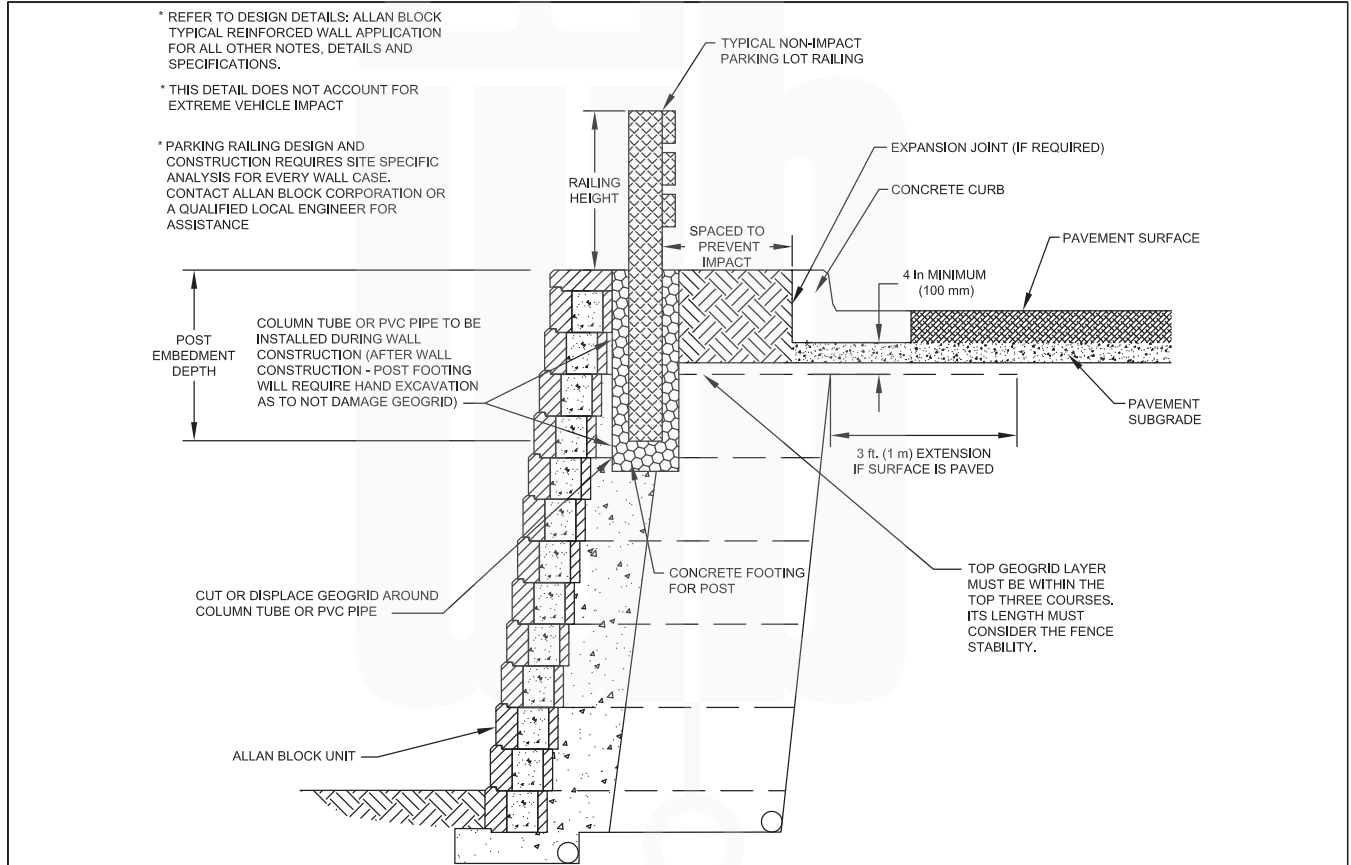

* REFER TO DESIGN DETAILS: ALLAN BLOCK TYPICAL REINFORCED WALL APPLICATION FOR ALL OTHER NOTES, DETAILS AND SPECIFICATIONS.


* THIS DETAIL DOES NOT ACCOUNT FOR EXTREME VEHICLE IMPACT


* PARKING RAILING DESIGN AND CONSTRUCTION REQUIRES SITE SPECIFIC ANALYSIS FOR EVERY WALL CASE. CONTACT ALLAN BLOCK CORPORATION OR A QUALIFIED LOCAL ENGINEER FOR ASSISTANCE

Designed By:	Title: NON IMPACT RAILING WALL SECTION	Date:
Checked By:	 <p>The purpose of this drawing is for preliminary design only. This drawing should not be used for final design or construction without the certification of a professional engineer registered in the state in which the wall will be built. The accuracy and use of details contained in this document are the sole responsibility of the user. The user must verify each detail for accuracy as they pertain to their particular project. © 2005 Allan Block</p>	Project No:
Scale: NOT TO SCALE		Drawing No:



Impact Railing Wall Section

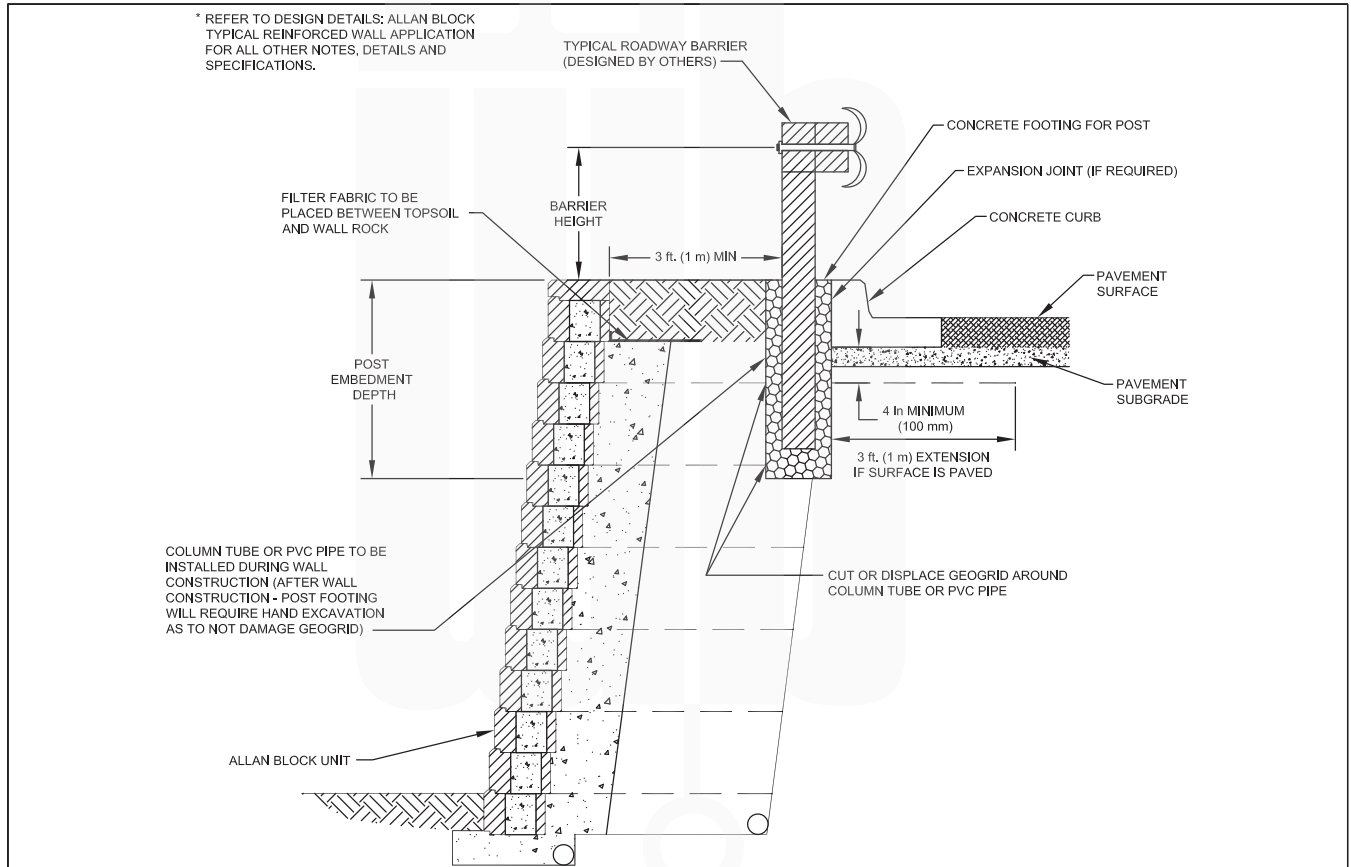

Designed By:	Title: IMPACT RAILING WALL SECTION	Date:
Checked By:	 <p>The purpose of this drawing is for preliminary design only. This drawing should not be used for final design or construction without the certification of a professional engineer registered in the state in which the wall will be built. The accuracy and use of details contained in this document are the sole responsibility of the user. The user must verify each detail for accuracy as they pertain to their particular project. © 2005 Allan Block</p>	Project No:
Scale: NOT TO SCALE		Drawing No: