





Allan Block – Typical Details


Typical Reinforced Wall Section

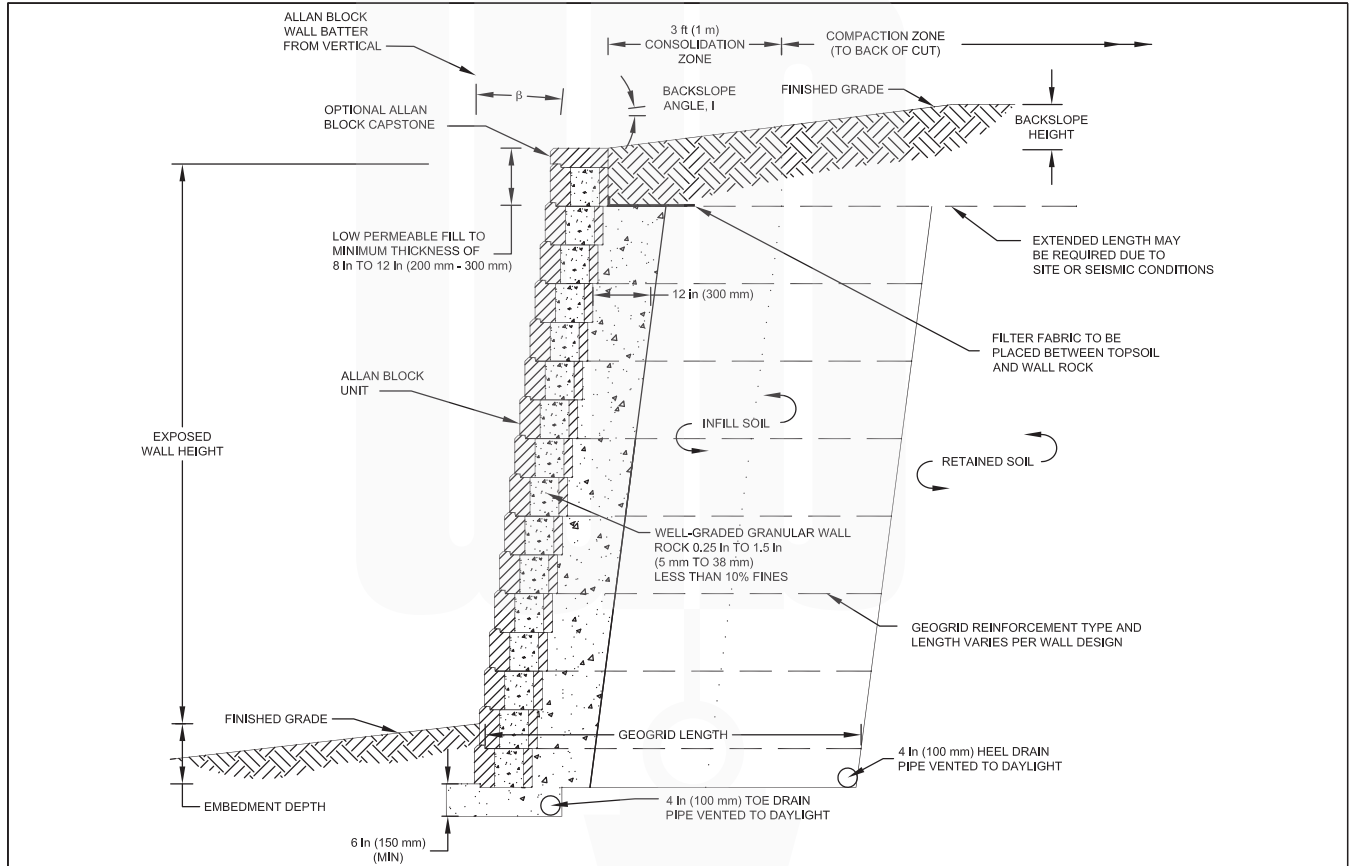


Designed By:	Title: TYPICAL REINFORCED WALL SECTION	Date:
Checked By:	 <p>The purpose of this drawing is for preliminary design only. This drawing should not be used for final design or construction without the certification of a professional engineer registered in the state in which the wall will be built. The accuracy and use of details contained in this document are the sole responsibility of the user. The user must verify each detail for accuracy as they pertain to their particular project. © 2005 Allan Block</p>	Project No:
Scale: NOT TO SCALE		Drawing No:




Typical Gravity Wall Section

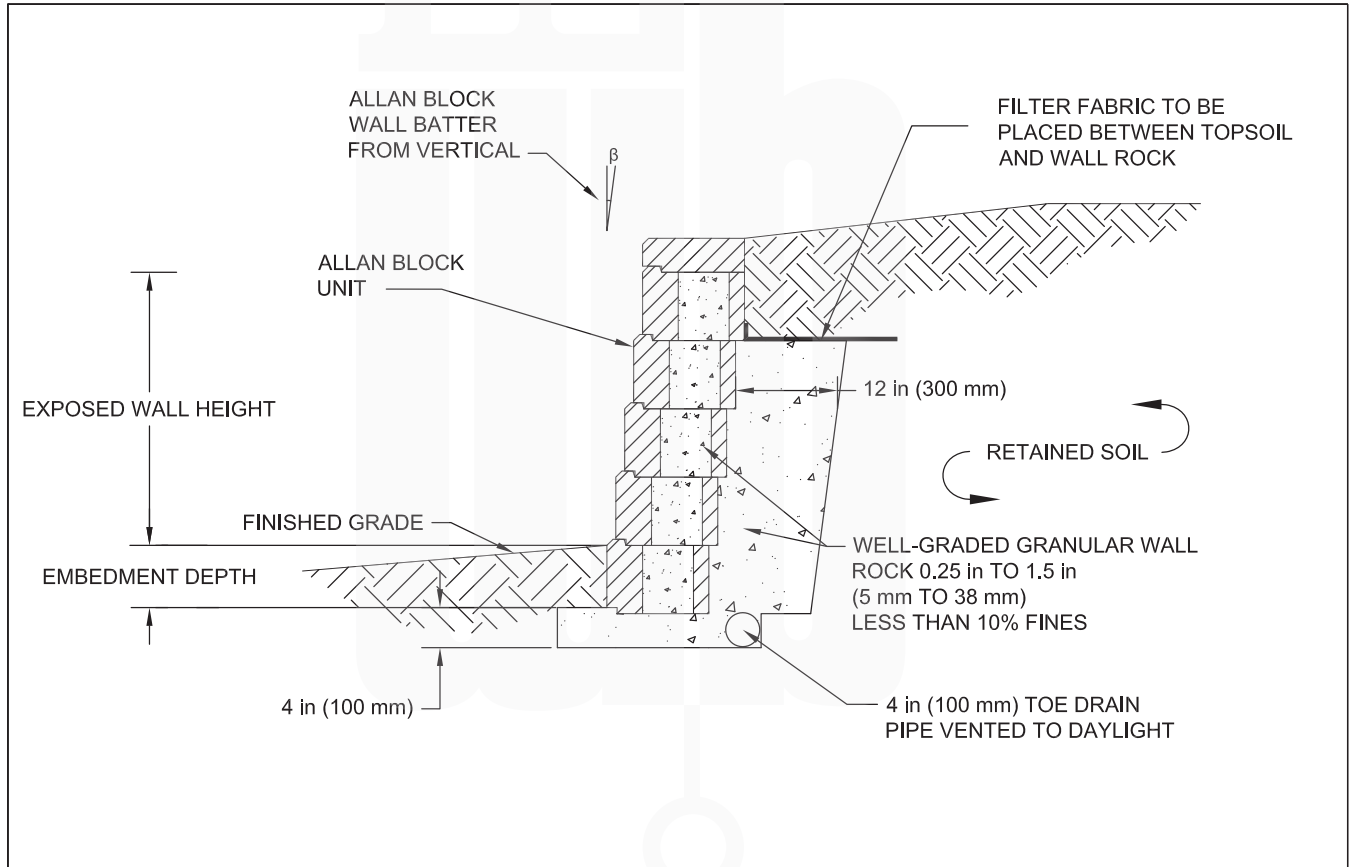


Designed By:	Title: TYPICAL GRAVITY WALL SECTION	Date:
Checked By:	 <p>The purpose of this drawing is for preliminary design only. This drawing should not be used for final design or construction without the certification of a professional engineer registered in the state in which the wall will be built. The accuracy and use of details contained in this document are the sole responsibility of the user. The user must verify each detail for accuracy as they pertain to their particular project. © 2005 Allan Block</p>	Project No:
Scale: NOT TO SCALE		Drawing No:




Inside Corner Application

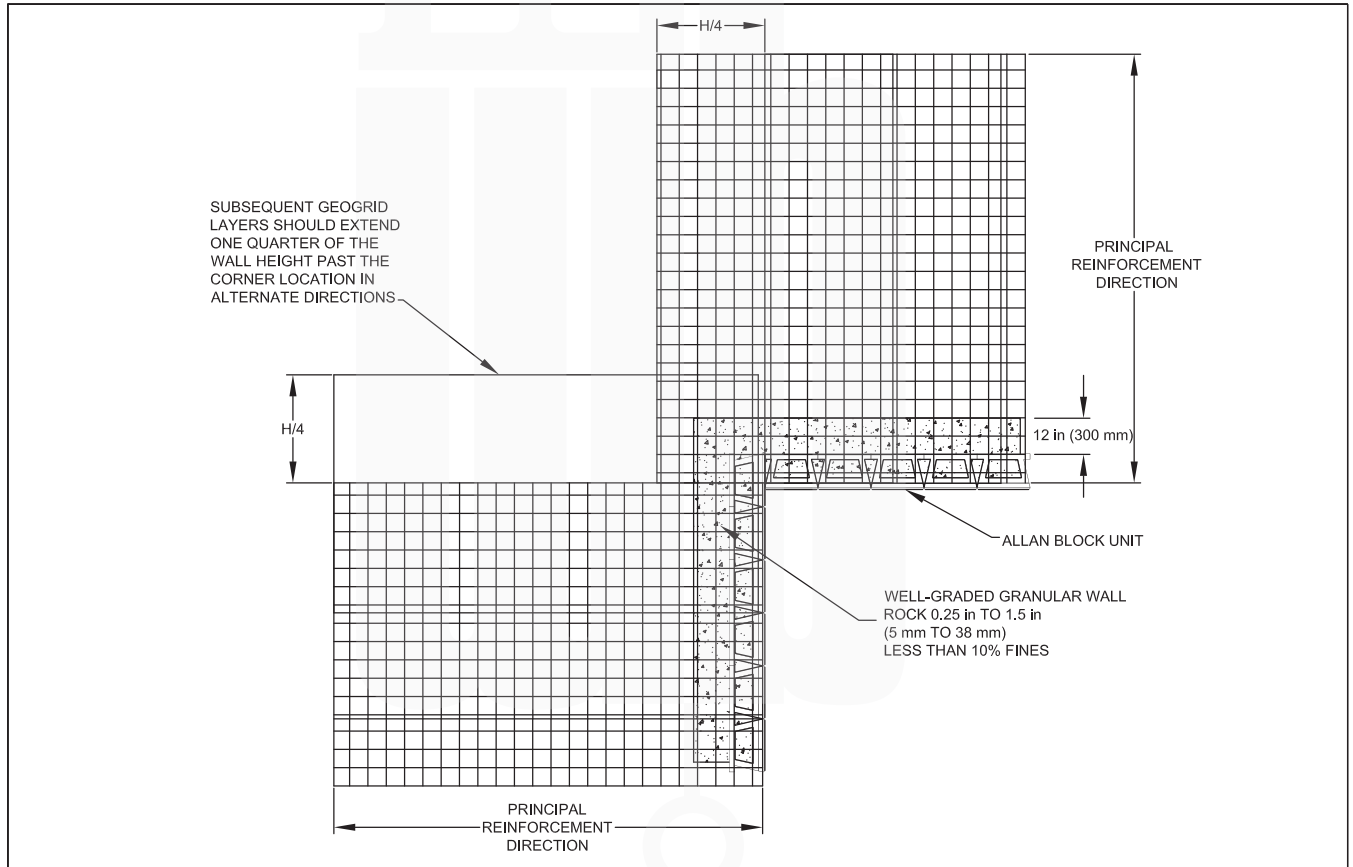


Designed By:	Title: INSIDE CORNER APPLICATION	Date:
Checked By:	 <p>The purpose of this drawing is for preliminary design only. This drawing should not be used for final design or construction without the certification of a professional engineer registered in the state in which the wall will be built. The accuracy and use of details contained in this document are the sole responsibility of the user. The user must verify each detail for accuracy as they pertain to their particular project. © 2005 Allan Block</p>	Project No:
Scale: NOT TO SCALE		Drawing No:




Outside Corner Application

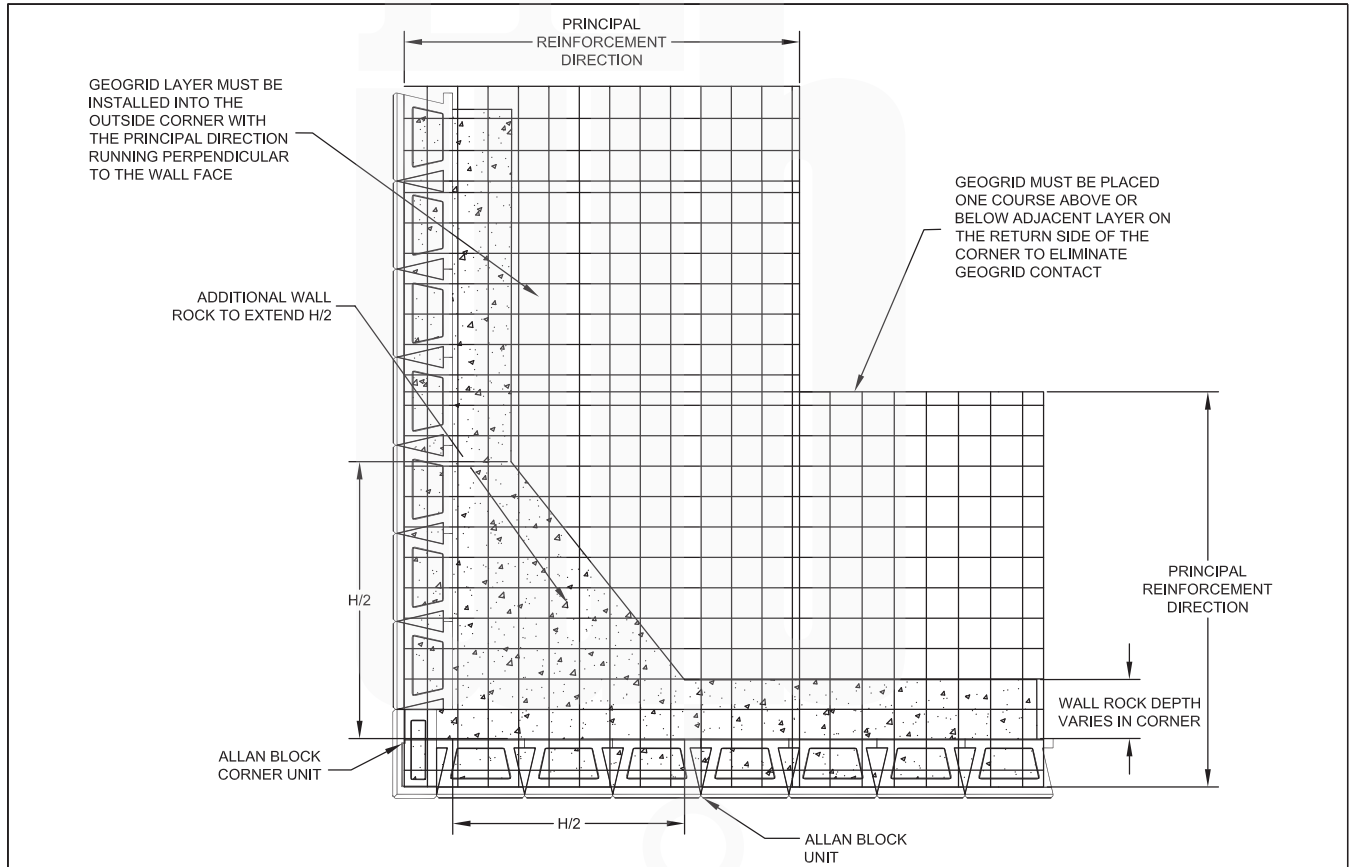

Designed By:	Title: OUTSIDE CORNER APPLICATION	Date:
Checked By:	 <p>The purpose of this drawing is for preliminary design only. This drawing should not be used for final design or construction without the certification of a professional engineer registered in the state in which the wall will be built. The accuracy and use of details contained in this document are the sole responsibility of the user. The user must verify each detail for accuracy as they pertain to their particular project. © 2005 Allan Block</p>	Project No:
Scale: NOT TO SCALE		Drawing No:




Inside Curve Application

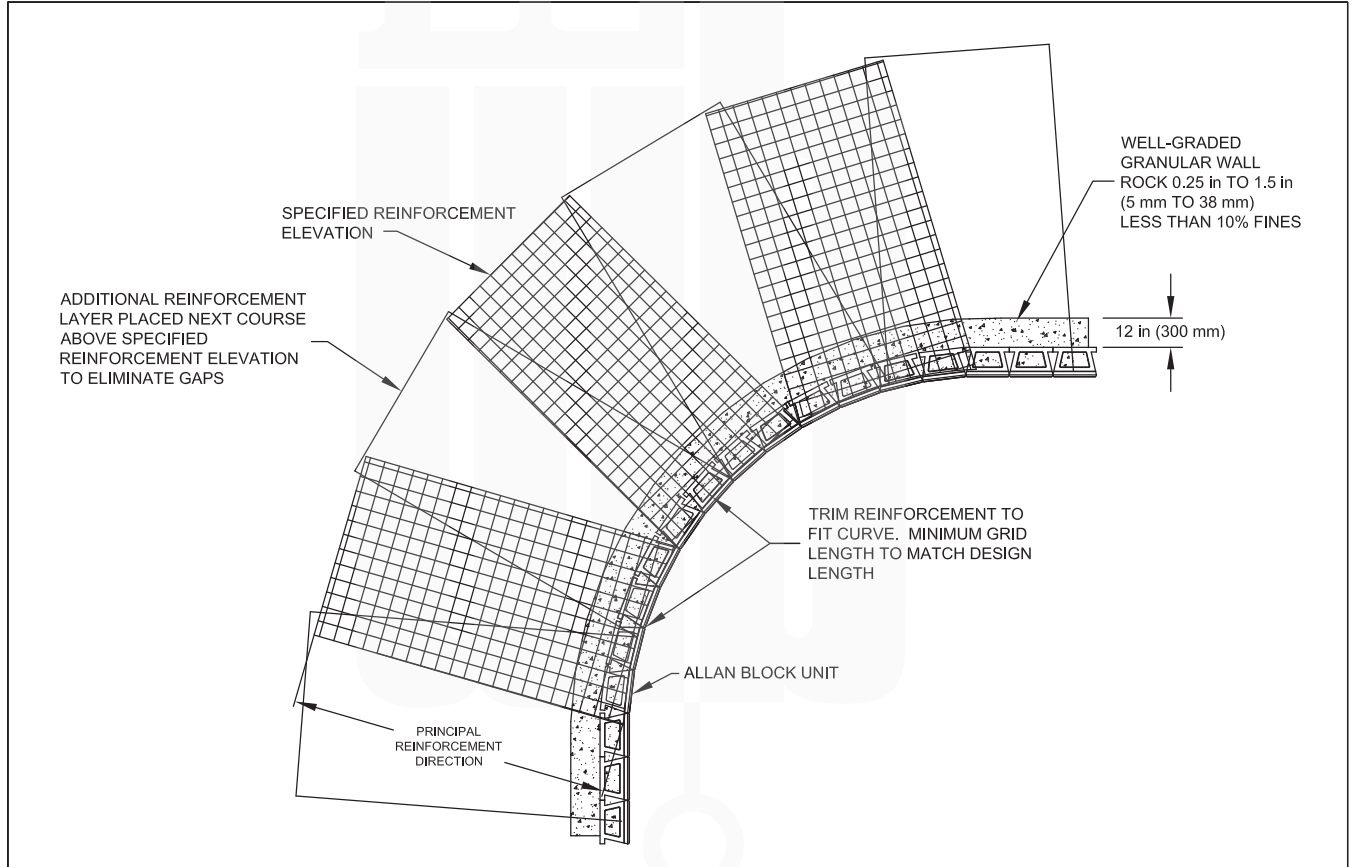


Designed By:	Title: INSIDE CURVE APPLICATION	Date:
Checked By:	 <p>The purpose of this drawing is for preliminary design only. This drawing should not be used for final design or construction without the certification of a professional engineer registered in the state in which the wall will be built. The accuracy and use of details contained in this document are the sole responsibility of the user. The user must verify each detail for accuracy as they pertain to their particular project. © 2005 Allan Block</p>	Project No:
Scale: NOT TO SCALE		Drawing No:




Outside Curve Application

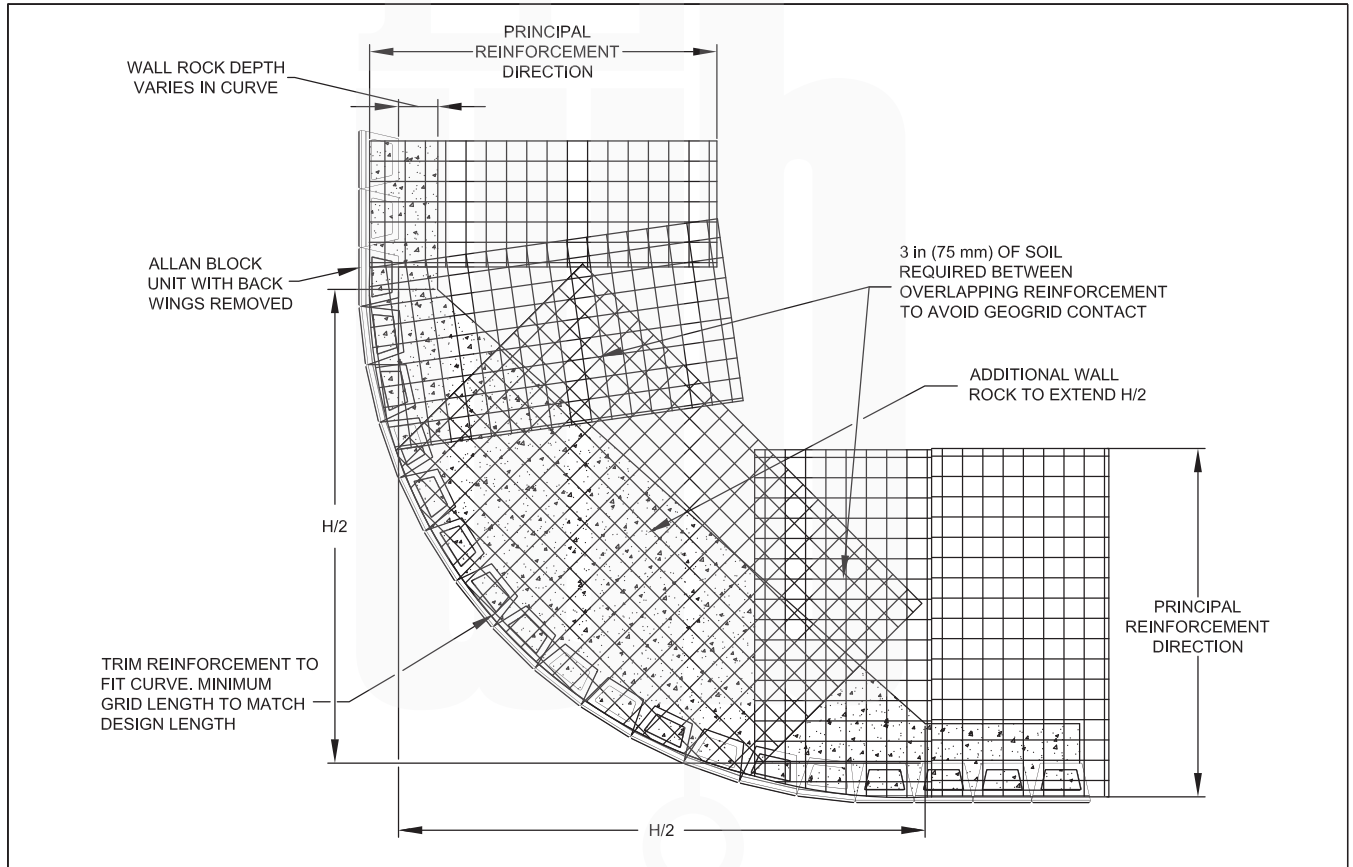


Designed By:	Title: OUTSIDE CURVE APPLICATION	Date:
Checked By:	 <p>The purpose of this drawing is for preliminary design only. This drawing should not be used for final design or construction without the certification of a professional engineer registered in the state in which the wall will be built. The accuracy and use of details contained in this document are the sole responsibility of the user. The user must verify each detail for accuracy as they pertain to their particular project. © 2005 Allan Block</p>	Project No:
Scale: NOT TO SCALE		Drawing No:




Step Up at Base

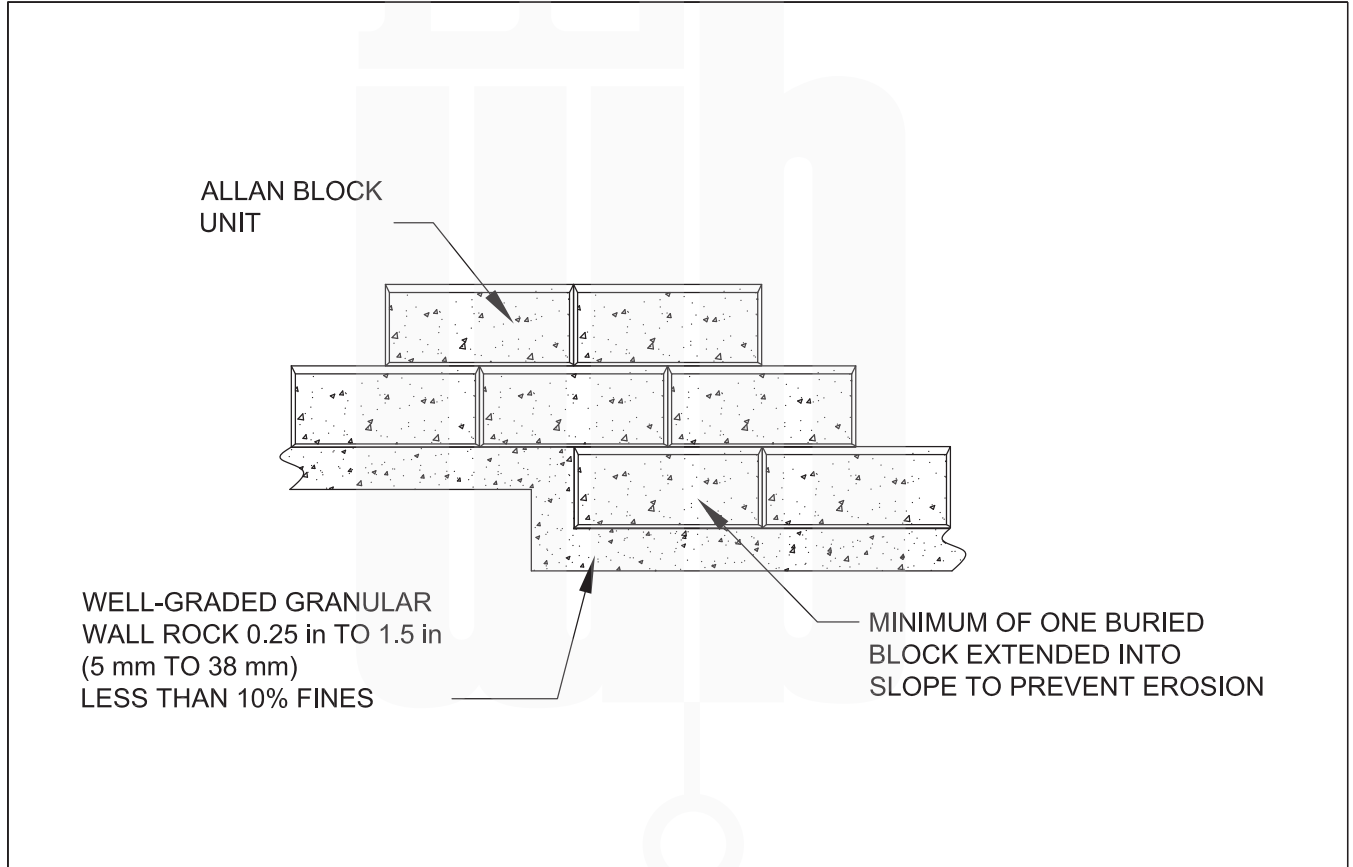


Designed By:	Title: STEP UP AT BASE	Date:
Checked By:	 <p>The purpose of this drawing is for preliminary design only. This drawing should not be used for final design or construction without the certification of a professional engineer registered in the state in which the wall will be built. The accuracy and use of details contained in this document are the sole responsibility of the user. The user must verify each detail for accuracy as they pertain to their particular project. © 2005 Allan Block</p>	Project No:
Scale: NOT TO SCALE		Drawing No:




Terraced Wall Section

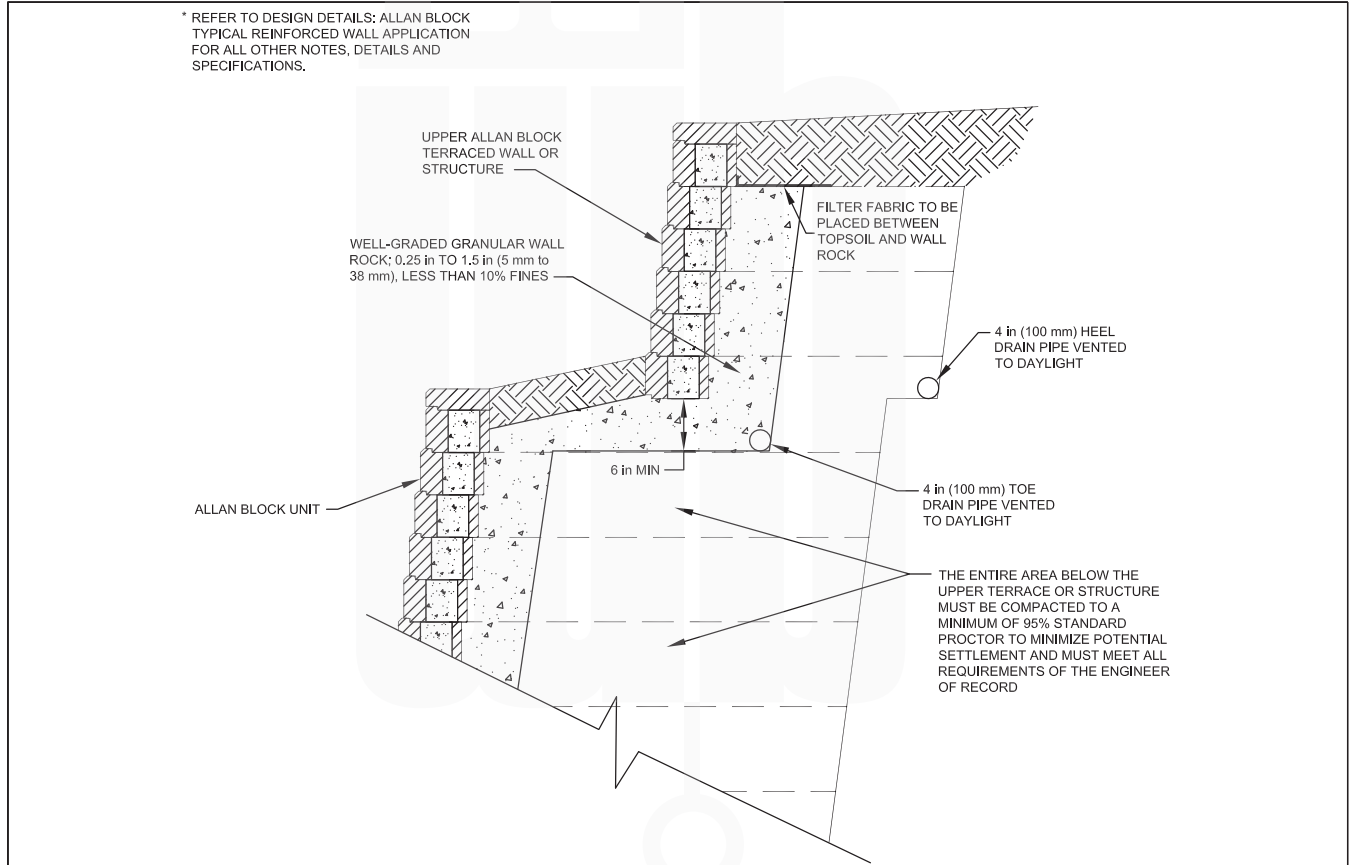

Designed By:	Title: TERRACED WALL SECTION	Date:
Checked By:	 <p>The purpose of this drawing is for preliminary design only. This drawing should not be used for final design or construction without the certification of a professional engineer registered in the state in which the wall will be built. The accuracy and use of details contained in this document are the sole responsibility of the user. The user must verify each detail for accuracy as they pertain to their particular project. © 2005 Allan Block</p>	Project No:
Scale: NOT TO SCALE		Drawing No:




Allen block Step up Finishing Details

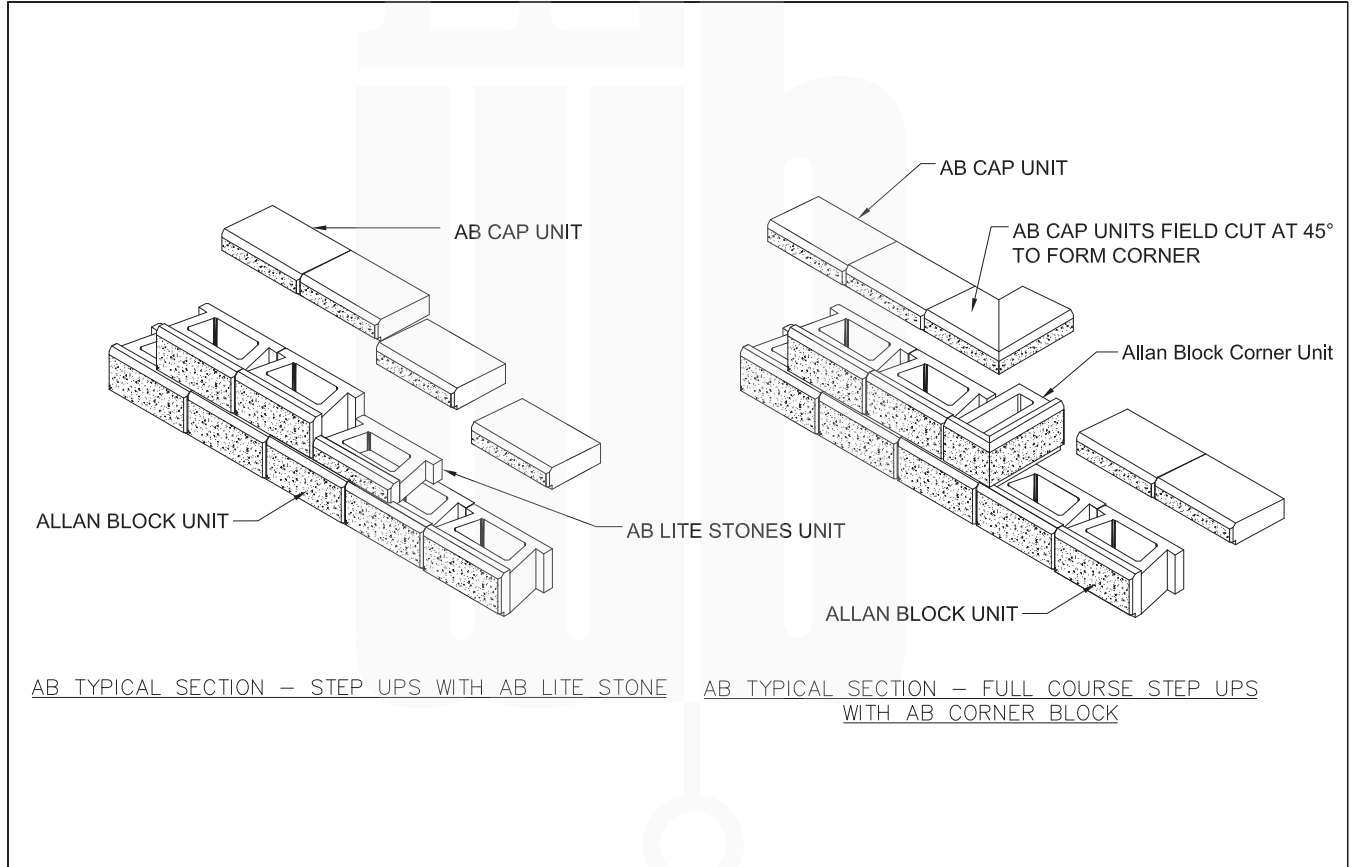

AB TYPICAL SECTION – STEP UPS WITH AB LITE STONE

AB TYPICAL SECTION – FULL COURSE STEP UPS WITH AB CORNER BLOCK

Designed By:	Title: AB STEP UP FINISHING DETAILS		Date:
Checked By:	 <p>The purpose of this drawing is for preliminary design only. This drawing should not be used for final design or construction without the certification of a professional engineer registered in the state in which the wall will be built. The accuracy and use of details contained in this document are the sole responsibility of the user. The user must verify each detail for accuracy as they pertain to their particular project. © 2005 Allan Block</p>	Project No:	
Scale: NOT TO SCALE		Drawing No:	