





Allan Block – Water Application Details


Water Application High Wall Section

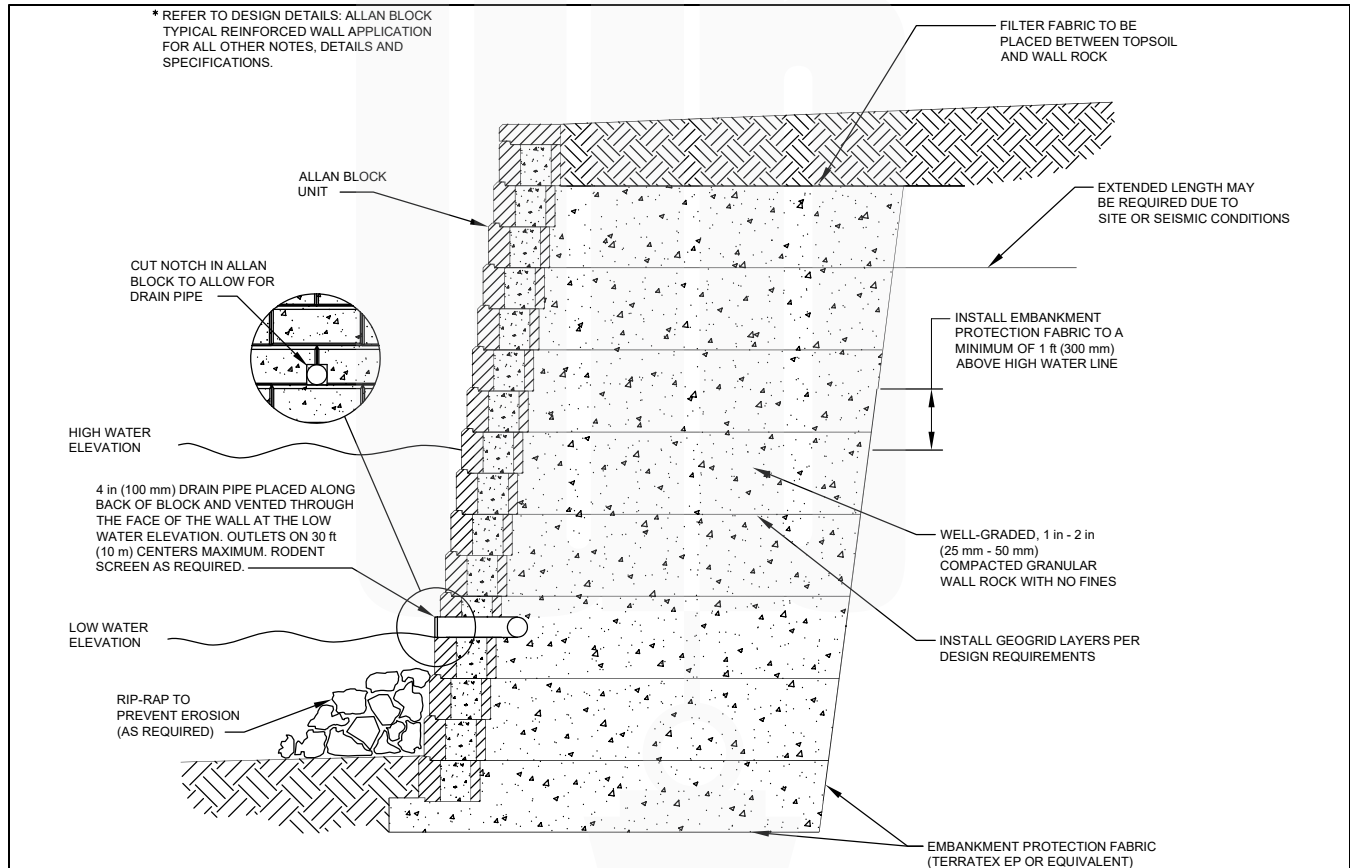


Designed By:	Title: WATER APPLICATION HIGH WALL SECTION	Date:
Checked By:	 <p>The purpose of this drawing is for preliminary design only. This drawing should not be used for final design or construction without the certification of a professional engineer registered in the state in which the wall will be built. The accuracy and use of details contained in this document are the sole responsibility of the user. The user must verify each detail for accuracy as they pertain to their particular project.</p> <p>© 2005 Allan Block</p>	Project No:
Scale: NOT TO SCALE		Drawing No:




Water Application Low Wall Section

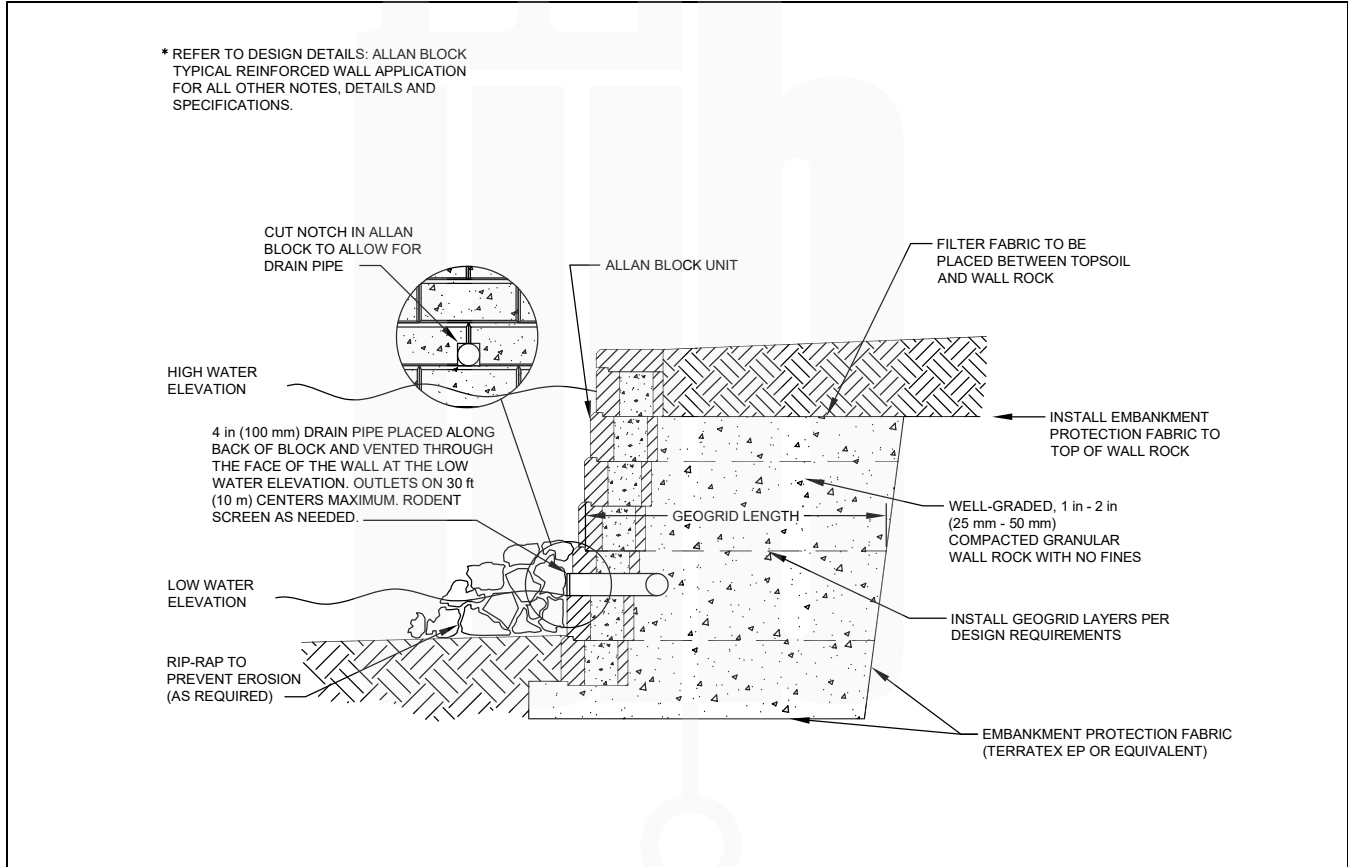


Designed By:	Title: WATER APPLICATION LOW WALL SECTION	Date:
Checked By:	 <p>The purpose of this drawing is for preliminary design only. This drawing should not be used for final design or construction without the certification of a professional engineer registered in the state in which the wall will be built. The accuracy and use of details contained in this document are the sole responsibility of the user. The user must verify each detail for accuracy as they pertain to their particular project. © 2005 Allan Block</p>	Project No:
Scale: NOT TO SCALE		Drawing No:




Storm Pipe Wall Section

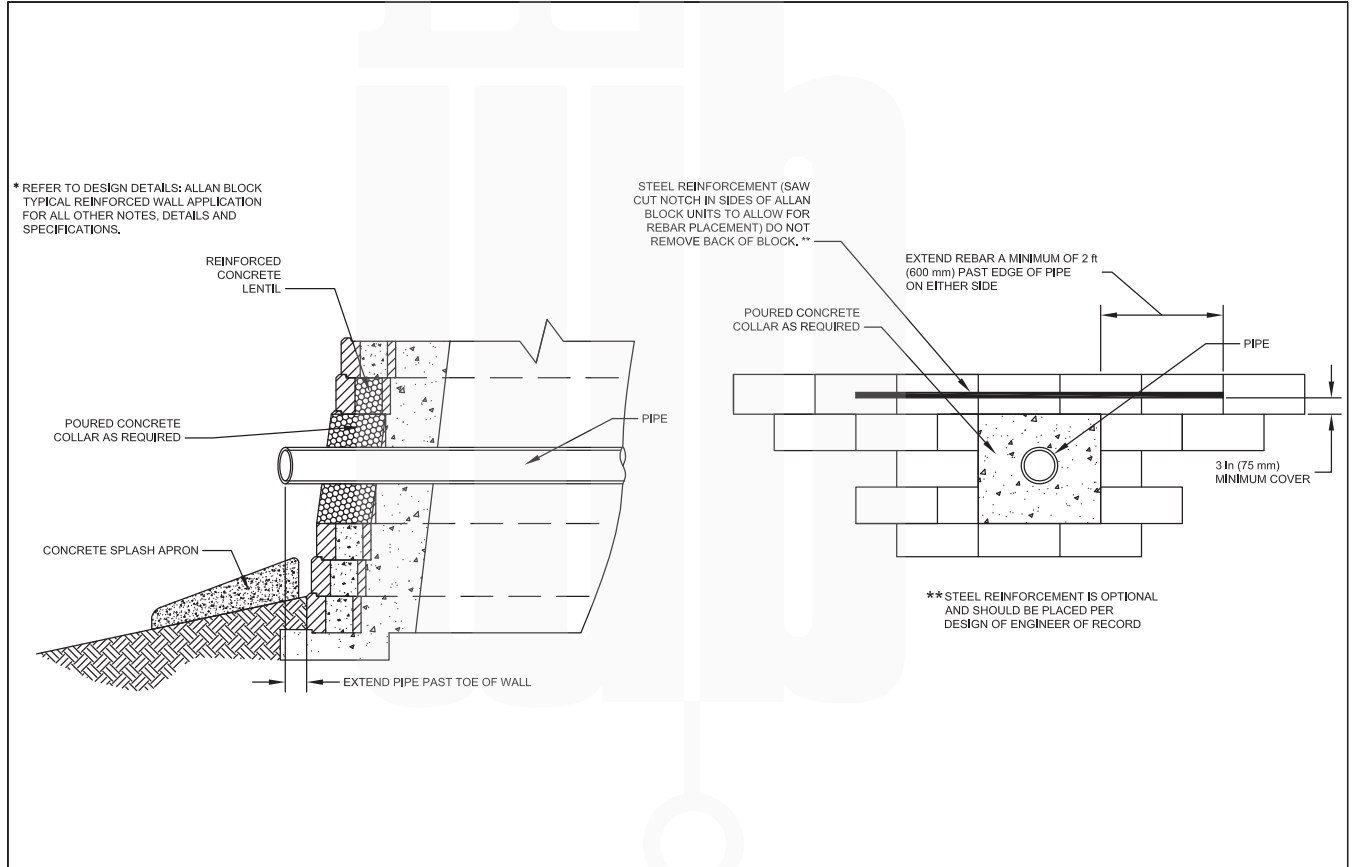

Designed By:	Title: STORM PIPE WALL SECTION	Date:
Checked By:	 <p>The purpose of this drawing is for preliminary design only. This drawing should not be used for final design or construction without the certification of a professional engineer registered in the state in which the wall will be built. The accuracy and use of details contained in this document are the sole responsibility of the user. The user must verify each detail for accuracy as they pertain to their particular project. © 2005 Allan Block</p>	Project No:
Scale: NOT TO SCALE		Drawing No:





Outside Corner Application

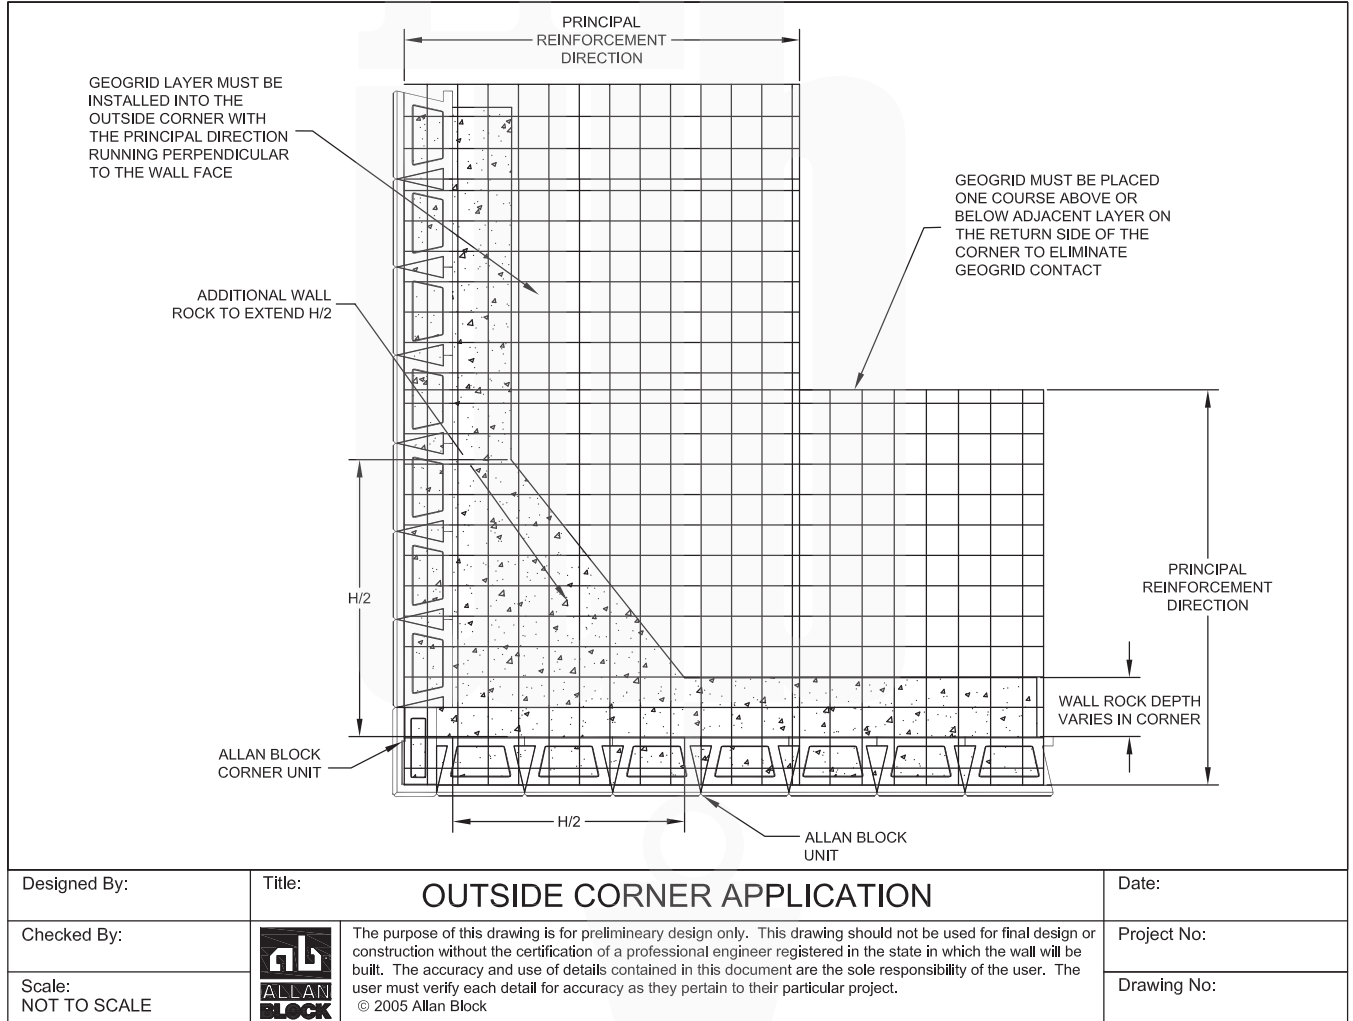




Inside Curve Application

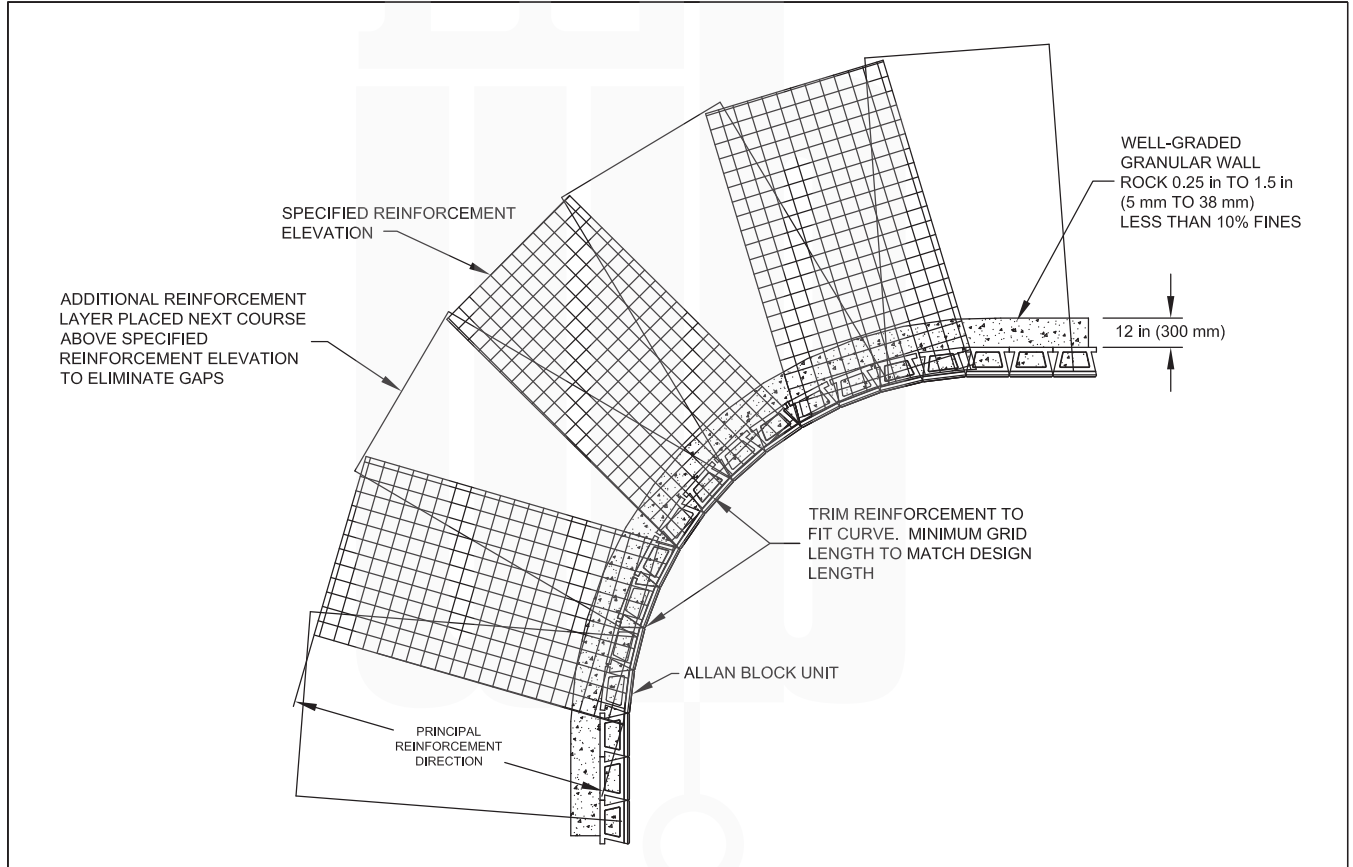


Designed By:	Title: INSIDE CURVE APPLICATION	Date:
Checked By:	 <p>The purpose of this drawing is for preliminary design only. This drawing should not be used for final design or construction without the certification of a professional engineer registered in the state in which the wall will be built. The accuracy and use of details contained in this document are the sole responsibility of the user. The user must verify each detail for accuracy as they pertain to their particular project. © 2005 Allan Block</p>	Project No:
Scale: NOT TO SCALE		Drawing No:




Outside Curve Application

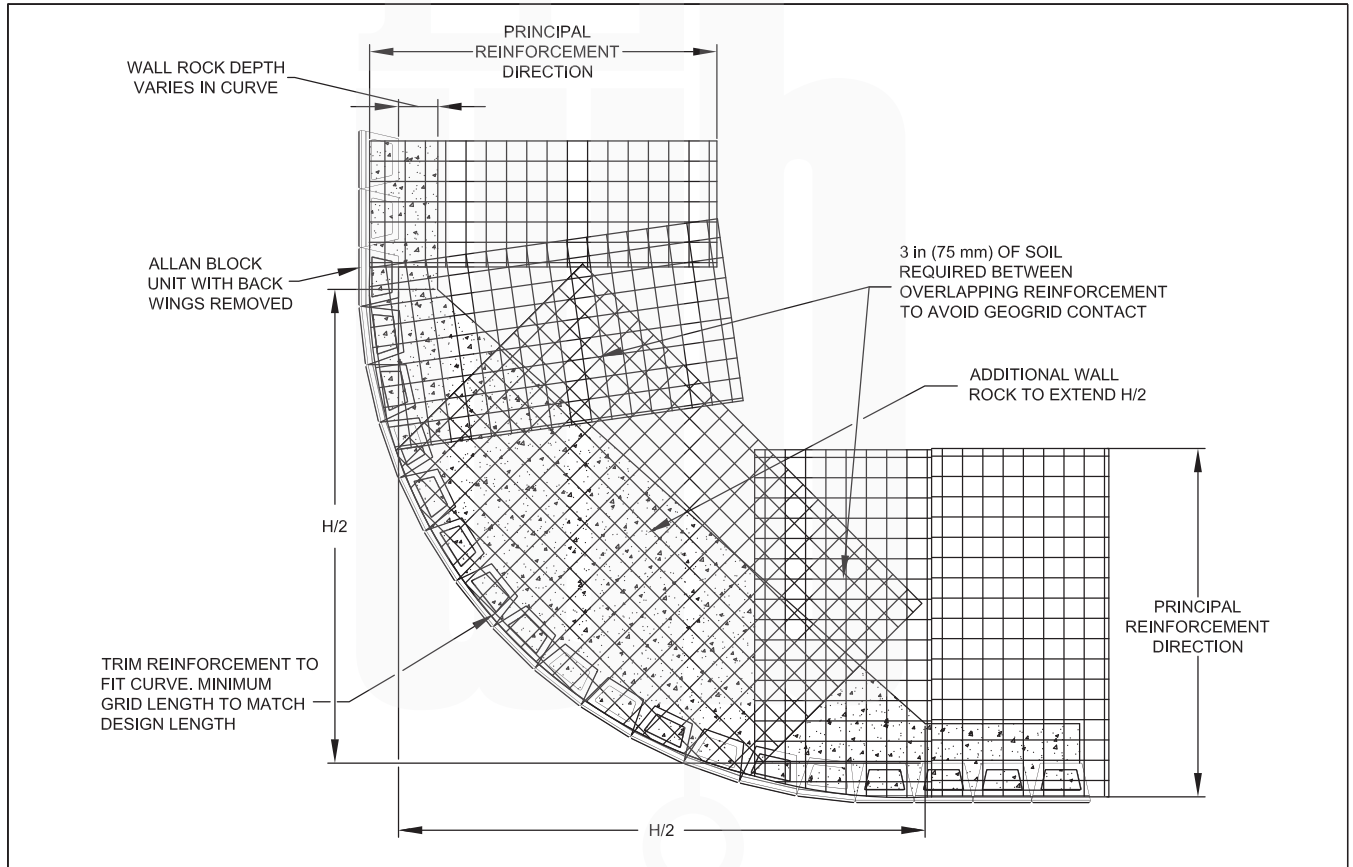


Designed By:	Title: OUTSIDE CURVE APPLICATION	Date:
Checked By:	 <p>The purpose of this drawing is for preliminary design only. This drawing should not be used for final design or construction without the certification of a professional engineer registered in the state in which the wall will be built. The accuracy and use of details contained in this document are the sole responsibility of the user. The user must verify each detail for accuracy as they pertain to their particular project. © 2005 Allan Block</p>	Project No:
Scale: NOT TO SCALE		Drawing No:




Step Up at Base

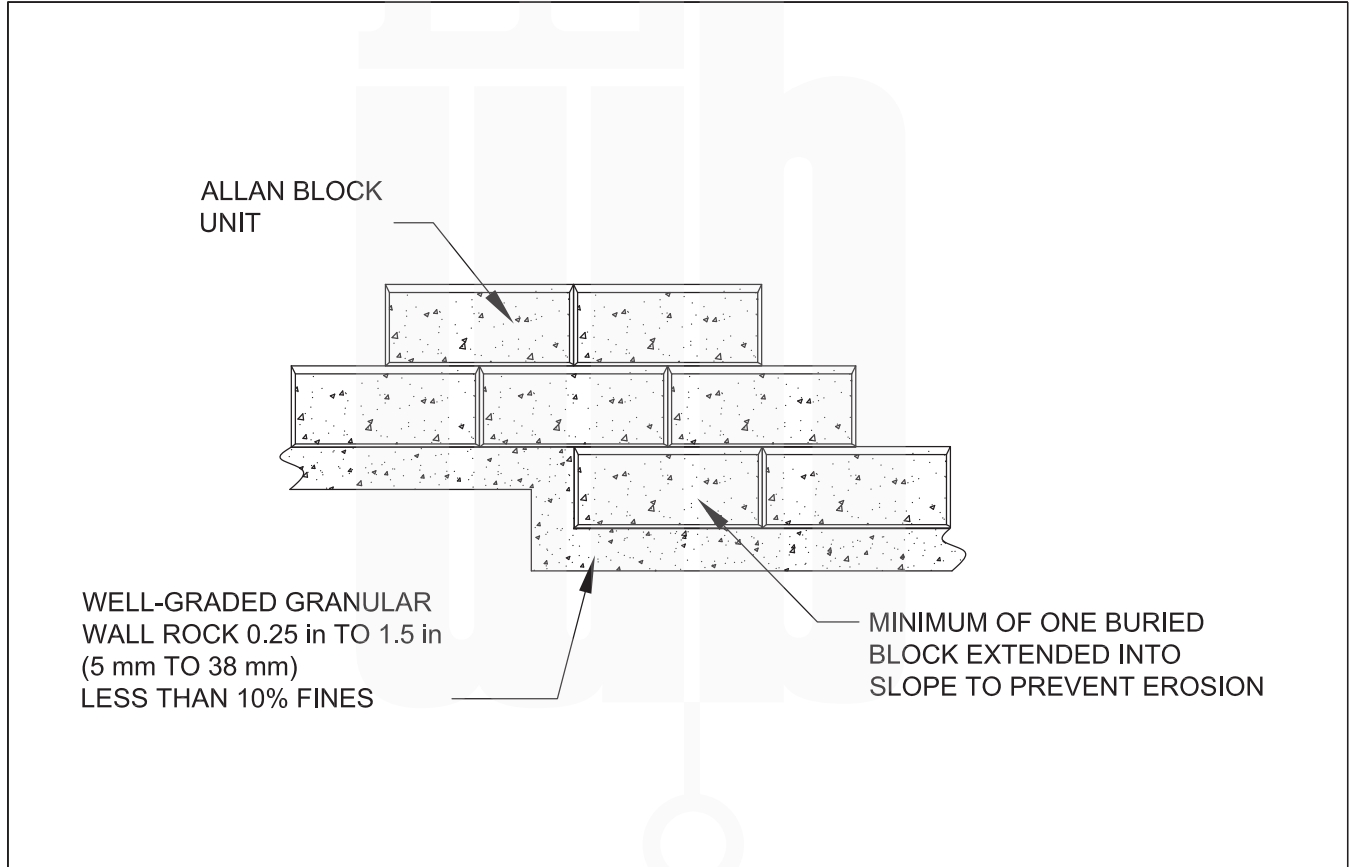


Designed By:	Title: STEP UP AT BASE	Date:
Checked By:	 <p>The purpose of this drawing is for preliminary design only. This drawing should not be used for final design or construction without the certification of a professional engineer registered in the state in which the wall will be built. The accuracy and use of details contained in this document are the sole responsibility of the user. The user must verify each detail for accuracy as they pertain to their particular project. © 2005 Allan Block</p>	Project No:
Scale: NOT TO SCALE		Drawing No:




Terraced Wall Section

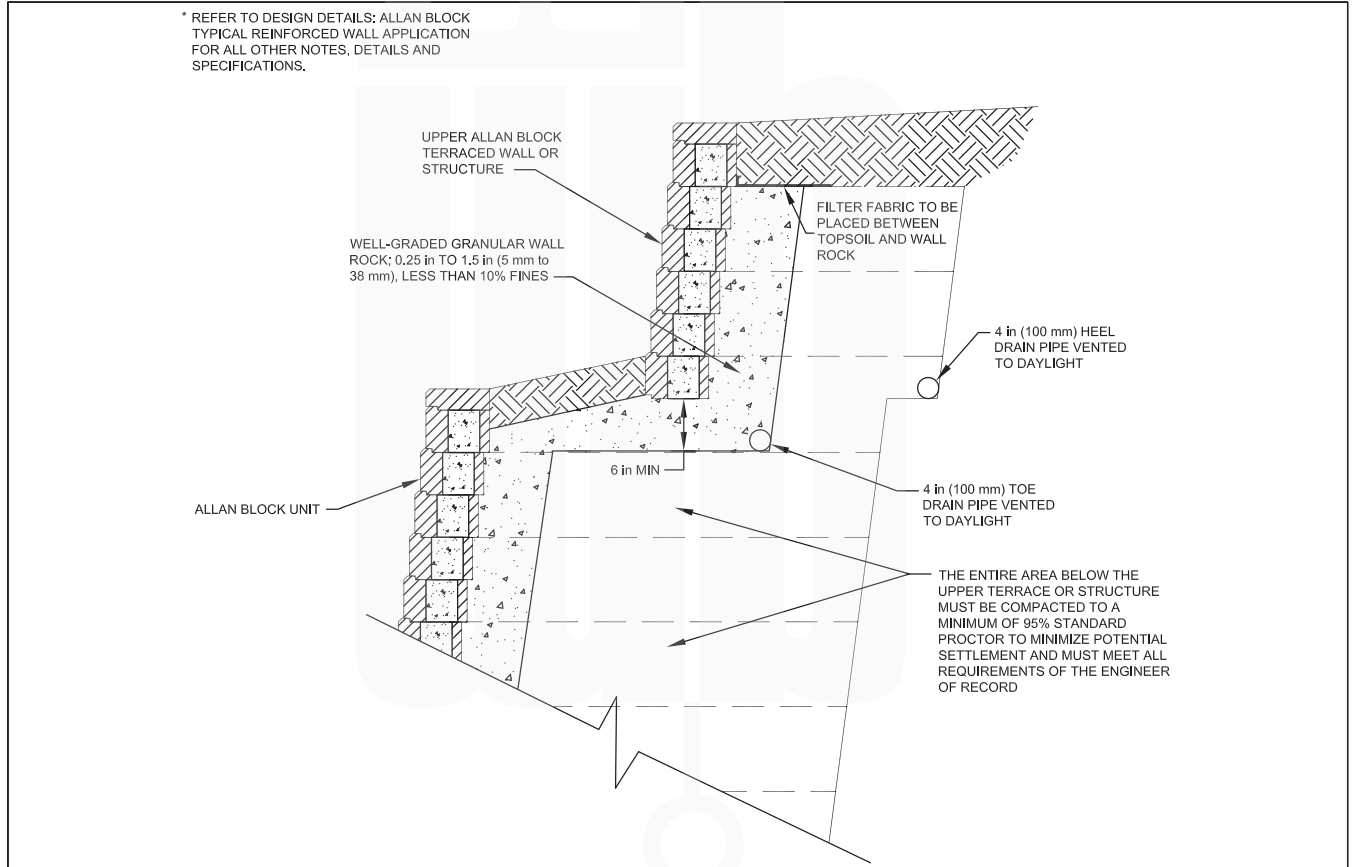

Designed By:	Title: TERRACED WALL SECTION	Date:
Checked By:	 <p>The purpose of this drawing is for preliminary design only. This drawing should not be used for final design or construction without the certification of a professional engineer registered in the state in which the wall will be built. The accuracy and use of details contained in this document are the sole responsibility of the user. The user must verify each detail for accuracy as they pertain to their particular project. © 2005 Allan Block</p>	Project No:
Scale: NOT TO SCALE		Drawing No:



Allen block Step up Finishing Details

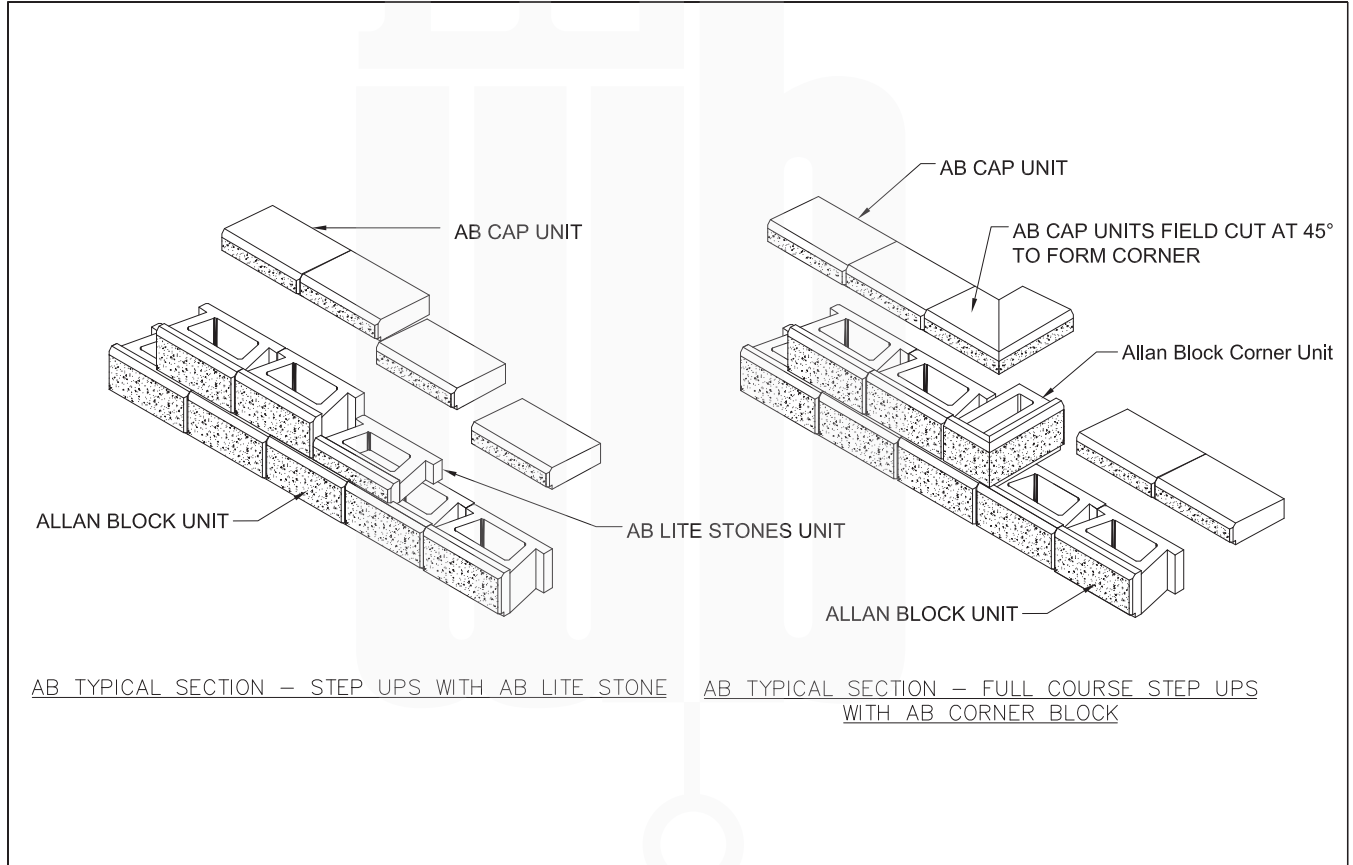

Designed By:	Title: AB STEP UP FINISHING DETAILS	Date:
Checked By:	 <p>The purpose of this drawing is for preliminary design only. This drawing should not be used for final design or construction without the certification of a professional engineer registered in the state in which the wall will be built. The accuracy and use of details contained in this document are the sole responsibility of the user. The user must verify each detail for accuracy as they pertain to their particular project. © 2005 Allan Block</p>	Project No:
Scale: NOT TO SCALE		Drawing No: